

handover-pack



[your brand]
[your tagline]

CEDIA[™] MEMBER

CRESTRON

HANDOVER PACK, LAST REV: 22/12/2016

[your brand]

[your tagline]

Introducing Your Brand:

We are a smart home automation company working on prestigious projects throughout the UK. Having worked in the audio visual industry for over 15 years, we started the company in 2009 and have achieved prestigious awards for our designs.

What We Do:

Our award winning team have a wealth of experience in the design, installation and calibration of the very best home automation systems available. Underlying our dedication to providing the very finest automation system possible is our love of technology. The better the system, the more enjoyment will be gained by our clients.

On every project we always remain acutely aware of the complexities of modern technology and how it can impact our lives. Our aim is to harness this technology to make life simpler and more enjoyable. We do this by getting the best out of our products with the help of our great team lovingly designing, testing and installing each element.

Our Services:

Distributed Audio

The audio distribution system acts as the backbone of the property-wide entertainment system. It distributes audio from components like Blu ray disc players and audio servers to all the speakers around a property. All of the equipment for this can be discretely installed to minimise the impact on the appearance and design of a property, whilst enhancing the living experience with entertainment everywhere.

Distributed Video

The video distribution system delivers high definition video signals to each TV across a property. The systems are designed to be compatible with HD devices and have the ability to deliver video from any device connected to any of the screens in a property independently of what anyone might be watching. As they are digital HDMI based systems they can also carry matching audio signals alongside the video to provide a complete audio visual distribution system to each TV in a property. This allows your favourite satellite channels to be available wherever you choose to watch them in full HD with digital sound.

Control

The control system provides a simple interface to various facets of a home, from music and TV entertainment right through to lighting control and intercom functions. Each panel is able to control all of these elements within the room it is situated in or across an entire property. The system can also provide the ability to use portable devices like smart phones and tablet computers to act as fully functional control interfaces giving complete control wherever you are.

Equipment Racking

The racking system is where all of the main equipment is housed. It is designed to keep all the equipment neatly stored and maintain a constant healthy operating temperature for all of the systems in a property with the use of correct thermal design. It helps to make our installations more structured and allows for easy maintenance. The racking system also includes cable management, to ensure the cable connections between devices and into a property are kept in a safe and orderly manner.

Home-Cinema

The cinema system delivers high definition video and audio for a truly cinematic experience. The video elements of the system are capable of providing high definition viewing for that totally immersive experience. While the audio system delivers reference level cinema surround sound with punch and impact to provide the perfect soundtrack accompaniment to the high definition video experience. Perfect sound and vision will blend together to provide hours of entertainment in your very own private cinema.

Lighting

The lighting control system provides dimming and pre-set mood lighting across an entire property. Each room can have a number of lighting scenes set up to combine different luminaires to give dramatic lighting effects or to show off features or centre pieces. As the eye cannot distinguish between 100% on or 90% dimmed the system can be programmed in such a way to provide energy savings by limiting the maximum power supplied to lights. The system is also designed to extend lamp life by using a soft start dim which reduces stress on lamps thus extending their lifespan.

Networking

The networking system includes all devices required to provide connectivity to the rest of the systems in a property. It includes where appropriate Wi-Fi and wired LAN devices. This system provides the connectivity backbone for the property-wide systems such as the AV

distribution and control systems. The network is designed and implemented to be as robust and reliable as possible within the limitations of the property.

Design & Integration

We are able to offer the following design and integration services:

Initial design & specification

Cable schedules and CAD design

Management and overseeing cabling works

Second fix installation

System programming and commissioning

Supply of system user manuals

Calibration

We are able to offer all our clients a professional THX / ISF calibration service. Calibration offers more natural colours and finer detail, most importantly, you will know that your television or projector is performing at its very best.

Awards:

Our team has won many industry awards over the years including best projects across multiple categories in the CEDIA awards, d-tools design award and Crestron's DigitalMedia award. Giving you the confidence that we can deliver to the most exacting standards.

How We Can Help You:

We are able to demonstrate a wide range of systems at our showroom, where you can road-test the best equipment and get a personalised design to your particular specifications. We pride ourselves on being able to work on a one-to-one basis with clients, interior designers and architects on projects large or small.

CEDIA:

Membership of CEDIA the Custom Electronics Design and Installation Association assures you get the best product and quality our industry has to offer. On the following page is our article taken from the Spring 2016 issue of the CEDIA communicates magazine.

THE KEY TO SUCCESS: DESIGN DOCUMENTATION

K eith Jones and
Kelly Ashforth
Business Partners
of London based system
integration company discuss
the importance of well-
designed documents for
smart home projects



Let's start with a statement and a question: "Design and documentation is a critical piece of any successful smart building or home technology system. As critical as the central rack and equipment or the client and end user, without which there would be no system at all." The question is simple and probably what most readers already have in mind: Why is design so critical? The benefits of a well-designed and properly documented system are numerous:

The first and perhaps most obvious we can borrow from Mr. Benjamin Franklin; "Failure to plan is planning to fail".

The second is another no brainer: Easier installation. Any system that has been thoroughly planned out and documented by a designer will have had all of the difficult issues of the site and the integration worked out before any wires are run. The installation will be much easier than attempting it without design or planning, allowing all parties involved to have a better understanding of what is required.

This neatly leads on to the third benefit: A well-designed, properly documented system will require less project management. If a project manager is to work efficiently, providing them with a complete set of design drawings to work


with has to be the enabler to this efficiency. Again the difficulties of the site and integration have been ironed out by the design process so there will be no time wasted dealing with these issues on site during installation. Inevitably the installation phases are where the integration company is exposed to greater risk and margin crushing expense to solve issues with

technology rather than designing through or around them earlier in the project.

The fourth benefit might seem less obvious but it is none the less important: Professional handover and project closure. The as built design documentation can be used as a physical tool to demonstrate to the client that the integration company has completed their work with due diligence. This makes the handover process much more professional and leads the parties to a natural point of closure, which helps the integrator prove completion and get their final payments in hand.

The fifth benefit follows on from handover: Ease of servicing. Imagine for a moment two installations one which has been well designed and properly documented, project A. And one which has had the least amount of design and drawings possible to get the job done, project B. Now fast forward a few years and assume that the installation team that installed both projects have moved on to bigger and better things. Which project will be easier to service? With project A an installer can study the drawings and get familiar with the job before attending site. With project B this can only be done on site making the installer look like they don't know what they are doing which is never a good position to be in.

The sixth and final benefit is perhaps less obvious but actually very important to the longevity and success of an integration business: The chance to enter awards to strengthen the brand. Without design and proper documentation awards are nigh on impossible to win.

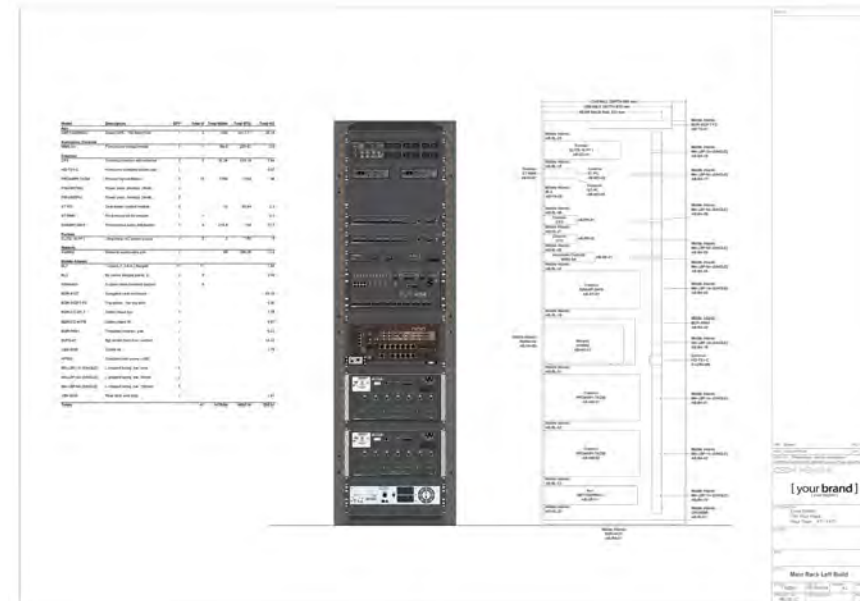


Businesses with awards and accreditations are more likely to win more jobs and more prestigious work. Business savvy clients (most of them) tend to look for businesses who are proud of their reputation and celebrate their success with awards and accreditations. Therefore we should consider a well-documented system design as a powerful sales tool.

All of these points neatly leads us into another question: What goes into a well-designed and documented system? The basic documents will consist of the following: A complete set of floor plans showing the locations of every piece of equipment going into the job and some mechanism to indicate what cables are required at each point. A set of elevation drawings showing wall mounted equipment and

detailing the equipment rack layouts and thermal design. A full set of connectivity schematics showing how each part of the system is interconnected and an IP addressing scheme. These are the basics, other documents might include a functional specification, scope of works and a programming scope.

How are these documents drawn up? This is where education is paramount. The person responsible for designing and documenting systems should be trained in design and have some certification to show this. However nothing counts more than experience in knowing how to assemble systems, knowing the nuances of what works well together and all the elements required to make each system work reliably and perform well.

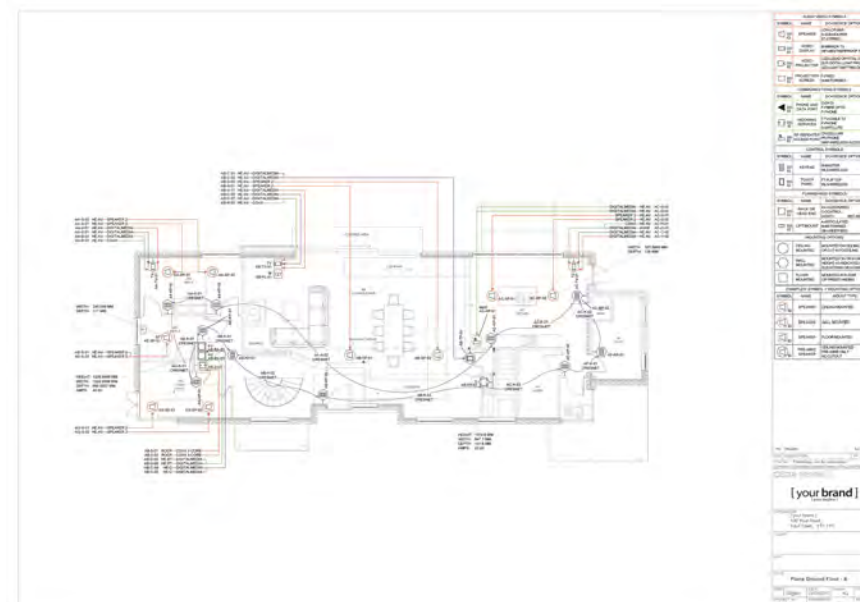

All of this leads us into the final and perhaps most poignant question here: How should integration companies charge for design?

Firstly there is a myth to be dispelled: "How can I charge for design and not risk losing the job to another integrator who doesn't charge for it?" This one is easy; imagine you are building a house and you have asked two architects to come up with a fee proposal and some ideas. Architect A comes back with a £50,000 fee and some initial ideas backed up by samples of jobs they have successfully completed and a long list of happy clients. Architect B comes back with just a simple statement "We will design your house for free". Which one would you choose? Hopefully Architect A because they have reassured you that they will do a good job and have a sustainable business.

It should be no different for integration companies: A typical project process should be to meet a client, gather their requirements, draw up a ballpark quotation and then ask for a retainer or design fee (the minimum fee here should be around 5% of the quotation) to carry out a detailed design exercise on the clients behalf for a suitable system to meet their requirements. This process along with all the other steps in delivering the job should be presented to the client at the initial meeting so they know straight away what to expect from the integrator and understand from the get go when they will be expected to pay for each phase of the project.

Integration companies should not be wary of charging design fees. They should be actively encouraged to do so and proudly show off their previous design work and how successful their projects are in the process. Design should be used by integration companies as a tool to win more work and gain access to more prestigious projects over time through awards and accreditation.

CRESTRON PROJECT

Brief

The brief for this project was quite specific, as the owners are big fans of Crestron equipment from their other properties and wanted to use as much of this as possible throughout the property. The projects complexity was further increased by the conversion of part of the loft space into a dedicated cinema room.

Cinema

The cinema became the focus of attention as we worked through various designs for this, relating to how the room should be orientated for the best possible performance. Once this was decided screen size calculations were made and the appropriate projector selected to deliver the correct light output at the surface of the screen allowing for calibration. The client was unsure which speakers would work best so after a visit to our showroom Artcoustic was selected as the preference due to their line array format and high efficiency. The client was keen to have the very latest technology so a Dolby Atmos 7.2.4 speaker system was specified. This meant that we would be unable to use a Crestron cinema processor so we opted for a Marantz 8802 but kept a couple of Procise power amplifiers to stick as closely to the brief as we could. It was during the demonstration at our showroom that the client fell in love with the Kaleidescape system and opted to include this as the main video source for the Cinema, which also led on to the selection of a full masking screen.

Video

Once the specification was agreed for the cinema we then set about achieving a similar level of performance throughout the property. Crestron's DigitalMedia system was chosen for video distribution to satisfy the client's brief and provide an element of futureproofing. In addition to the cinema projector there are Televisions in the lounge, kitchen and each of the four bedrooms. The client requested that all screens should be of a uniform size and mounted on articulated brackets to optimise viewing

angles. As the lounge featured a log burner as the main centre piece it was decided to fit the television in this room in a concealed cabinet. A motorised lift was specified for this room to give easy viewing of the screen at the touch of a button.

Audio

Crestron's Sonnex system was specified for audio distribution and to be true to the brief we decided to specify Crestron Excite ceiling speakers to keep the Crestron sound intact end to end. The client was keen to have the maximum flexibility when it came to music sources and streaming so an Autonomic five zone audio server was specified to maximise the flexibility of this eight zone system.

Control

Control of all of this is through iPad's with one for each room with a Television. There is also a Crestron 7" touch panel in the lounge, master bedroom and cinema to give wired backup control in the event of a failure in the iPads. Everything is controlled with a single CP3 and there are a total of six Crestron ST-PC's to provide remote mains cycling of equipment such as Sky boxes.

Racking

Two full height equipment racks were required to house all of the equipment which meant a little remodelling was required to the cupboard designated for this. Due to the remote nature of the property we decided to include an APC UPS in each rack along with a Furman conditioner to help protect the equipment in the event of issues with the power supply to the house.

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Lighting

Following the client's requirements a Crestron lighting control system was specified to control the lighting throughout the property. Limited space in the cupboard designated for this forced us to keep the number of dimmers down so that they could be housed in a single CAEN enclosure. The client requested a satin nickel finish for all the Crestron switches to match the other sockets and switches used in the property.

Networking

To keep the networking as secure as possible Cisco Meraki access points were specified sitting on a backbone of Crestron PoE switches and running out through a Cisco modem router. This allows us to monitor the performance and health of the system from off site and contact the client when we see a problem on the network.

Interface

Another challenge for us was that the client has an elderly wheelchair bound relative who regularly visits. This meant that one of the bedrooms is downstairs and there are a couple of ramps in the main living area to cover the varying levels between the kitchen hall and lounge. This meant that it was paramount to ensure all the items on the ground floor remained accessible to a wheelchair user and also that there were some simple pages within the basic system controls on the touch panels and iPads. This challenge was met with great enthusiasm by our programming team as they had long wanted to create a two phase interface keeping the overall system controls super simple and basic while providing additional controls and settings in a deeper menu that required a code to access.

Images

The build of this project ran out to just over a year and the clients were very pleased with the end result which you can see in the following pictures.



Carl Icahn Tweets About Apple Letter

By Carl Icahn
Just sent a letter to Tim Cook. Full letter will be disclosed on my website, the Shareholders' Square Table, which will be launched tomorrow.

21:28:07 KAROBANK SAID TO AGREE TO \$7B
23 OCT SETTLEMENT OVER LIBOR CLAIMS

Symbol	Price	%
NYSE:KRO	130.00	+1.00%
NYSE:KRO	130.00	+1.00%







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CEDIA[™] MEMBER

CRESTRON

SITE PACK, LAST REVISION: 25/01/2017

CABLING INORFMATION

IT IS ESSENTIAL THAT THE FOLLOWING INFORMATION IS READ AND UNDERSTOOD TO ENSURE THE SYSTEMS SUPPLIED AND INSTALLED PERFORM TO THE HIGHEST STANDARD.

1: MAIN CONTRACTOR TO UNDERTAKE THE FOLLOWING:

- 1.1: ENSURE ALL SUB-CONTRACTORS ARE AWARE OF THE STANDARDS AS SET OUT HERE.
- 1.2: ENSURE THAT ALL CABLES ARE STORED IN DRY SURROUNDINGS AT TEMPERATURES NOT LOWER THAN 5C.
- 1.3: NOTIFY WHEN ALL CABLING AND BACK BOXES HAVE BEEN INSTALLED AND CUT OUTS HAVE BEEN MADE FOR SPEAKERS SO TESTING AND CERTIFICATION CAN COMMENCE

2: ELECTRICAL CONTRACTOR TO UNDERTAKE THE FOLLOWING:

- 2.1: INSTALL ALL ULTRA LOW VOLTAGE ELECTRICAL CABLING TO THE CORRECT POSITIONS AS INDICATED WITHIN THIS SITE PACK.
- 2.2: ALL CABLING TO BE CLEARLY LABELLED AT BOTH ENDS ONLY WITH THE CABLE ID'S SHOWN WITHIN THIS SITE PACK - FAILURE TO CORRECTLY LABEL THE CABLING MAY RESULT IN ADDITIONAL CHARGES BEING MADE TO THE CLIENT.
- 2.3: SUPPLY AND FIT ALL BACK BOXES AS DETAILED WITHIN THIS SITE PACK. NOTE THAT HEIGHTS AND POSITIONS OF BACK BOXES ARE INDICATED WITHIN THIS SITE PACK BUT ARE SUBJECT TO CONFIRMATION BY THE ARCHITECT.
- 2.4: CUT OUT ALL IN-CEILING AND IN-WALL SPEAKER POSITIONS AS INDICATED WITHIN THIS SITE PACK - CUT OUT DETAILS WILL BE PROVIDED UPON REQUEST.
- 2.5: INSTALL ANY ADDITIONAL MAINS SUPPLIES AS INDICATED WITHIN THIS SITE PACK.
- 2.6: IN THE CASE OF A LIGHTING CONTROL SYSTEM OR MAINS VOLTAGE RELAYS/CONTROLS, THE ELECTRICAL CONTRACTOR SHALL BE RESPONSIBLE FOR ALL TERMINATIONS OF THE HIGH VOLTAGE SYSTEMS IN LINE WITH CURRENT BUILDING/ELECTRICAL REGULATIONS.
- 2.7: LEAVE ALL CABLES LOOSELY COILED 1M ABOVE FFL (FINISHED FLOOR LEVEL) TO AVOID CRUSHING, DAMP, AND COLD.

3: WE ASK THAT THE FOLLOWING STANDARDS ARE FOLLOWED TO ENSURE THE PERFORMANCE OF THE STRUCTURED CABLING:

- 3.1: IN ORDER TO REDUCE ELECTRO-MAGNETIC INTERFERENCE, ALL ULTRA LOW VOLTAGE CABLING IS TO BE RUN AT LEAST 500MM FROM ANY LOW VOLTAGE (MAINS 120-230V) CABLING.
- 3.2: WHERE ULTRA LOW VOLTAGE CABLING CROSSES LOW VOLTAGE CABLING (MAINS 120-230V), IT SHOULD DO SO AT 90 DEGREES (RIGHT ANGLES).
- 3.3: IT IS NOT RECOMMENDED THAT ANY ULTRA LOW VOLTAGE CABLING IS BENT AT A RADIUS OF LESS THAN 60MM.
- 3.4: NO ULTRA LOW VOLTAGE CABLING SHOULD BE EXPOSED TO A PULLING TENSION IN EXCESS OF 10N.
- 3.5: UNLESS OTHERWISE INDICATED, AT EQUIPMENT POSITIONS/HEAD END, AT LEAST 5M OF SPARE CABLE SHOULD BE LEFT (FROM FLOOR OR CEILING LEVEL).
- 3.6: UNLESS OTHERWISE INDICATED, PLEASE LEAVE 1M OF SPARE CABLE AT ANY WALL OUTLET/CONTROL POINT.
- 3.7: AT CEILING SPEAKER LOCATIONS, PLEASE LEAVE 1M OF SPARE CABLE UNLESS OTHERWISE INDICATED - PLEASE LEAVE 2M LOOPS WHERE LOOPS ARE INDICATED.
- 3.8: IT IS NOT RECOMMENDED THAT ANY OPTICAL FIBRE CABLE IS BENT AT A RADIUS OF LESS THAN 200MM.
- 3.9: IT IS RECOMMENDED THAT OPTICAL FIBRE CABLE IS ONLY CUT WITH APPROVED FIBRE CUTTING TOOLS.

NO ALTERATIONS ARE TO BE MADE WITHOUT PRIOR CONSULTATION.

EXPLANATION OF CABLE TEXT ELEMENTS:


CABLE ID: AA-S-02 – LOWEST FLOOR (A) TOP LEFT ROOM (A) SPEAKER CABLE (S) ID NUMBER (02)

CABLE TYPE: SPEAKER 2 – 2 CORE SPEAKER CABLE

CABLE DESTINATION: HE: AV – AUDIO/VIDEO HEAD END

EXPLANATION OF SYMBOLS

TWO TEXT ATTRIBUTES ARE USED TO DESCRIBE SYMBOLS AS SHOWN:

SYMBOL	NAME	DO=DEVICE OPTIONS
 DO ID	SPEAKER	LCR-LCR BAR S-SUBWOOFER ST-STEREO

DO = DEVICE OPTIONS - KEY DESCRIPTION OF THE TECHNOLOGY UNIQUE TO EACH SYMBOL, SEE ABOVE FOR EXAMPLES AND MAIN LEGEND FOR DEVICE OPTIONS FOR EACH SYMBOL







ID = ID REFERENCE – ALPHANUMERIC CHARACTERS IDENTIFYING THE SYMBOL. FORMAT XX-YY-00

XX = ROOM ID (FLOORS ARE LABELLED WITH A LETTER STARTING WITH A FOR THE LOWEST FLOOR, ROOMS ARE GIVEN A LETTER STARTING WITH A FOR TOP LEFT ROOM THEN GOING IN ROWS AS IF READING A BOOK, SO AA IS TOP LEFT ROOM ON THE LOWEST FLOOR).


YY = ITEM CODE (SP = SPEAKER, KP = KEYPAD, DT = DIGITAL TELEVISION, ETC.).

00 = UNIQUE ITEM ID NUMBER (01-99)
E.G AA-SP-01 = LOWEST FLOOR/TOP LEFT ROOM-SPEAKER-1

THREE SHAPE OUTLINES ARE USED TO DESCRIBE THE MOUNTING OF EACH DEVICE AS SHOWN:

MOUNTING OPTIONS		
	CEILING MOUNTED	MOUNTED ON CEILING OR CUT INTO CEILING
	WALL MOUNTED	MOUNTED ON OR IN WALL HEIGHT AS INDICATED IN ELEVATIONS OR AS MARKED
	FLOOR MOUNTED	MOUNTED IN FLOOR OR FREESTANDING
EXAMPLES: SYMBOL + MOUNTING OPTION		
SYMBOL	NAME	MOUNT TYPE
 ID	SPEAKER	CEILING MOUNTED
 ID	SPEAKER	WALL MOUNTED
 ID	SPEAKER	FLOOR MOUNTED

ITEMS THAT WILL NOT BE INSTALLED BUT STILL REQUIRE WIRES RUNNING FOR FUTURE USE OR INSTALLATION ARE INDICATED WITH A BLACK SURROUNDING BOX AS SHOWN BELOW:

SYMBOL	NAME	DO = DEVICE OPTIONS
 ID	PRE-WIRE SPEAKER	ALL DEVICE OPTIONS AS PER MAIN SYMBOLS

OPTICAL FIBRE – BEND RADIUS = 200MM

SIVIOA BLINDS CABLE – BEND RADIUS = 90MM

RG6 COAXIAL CABLE – BEND RADIUS = 65MM
CONTROL CABLE – BEND RADIUS = 65MM

CAT6E CABLE - BEND RADIUS = 48MM

2 & 4 CORE SPEAKER CABLE – BEND RADIUS = 35MM

AUDIO SIGNAL CABLE – BEND RADIUS = 25MM

NOTE: THIS DIAGRAM IS ONLY FOR USE ON A1

AUDIO SIGNAL CABLE – BEND RADIUS = 25MM

2 & 4 CORE SPEAKER CABLE – BEND RADIUS = 35MM

CAT6E CABLE -BEND RADIUS = 48MM

RG6 COAXIAL CABLE – BEND RADIUS = 65MM
CONTROL CABLE – BEND RADIUS = 65MM

SIVIOA BLINDS CABLE – BEND RADIUS = 90MM

OPTICAL FIBRE – BEND RADIUS = 200MM

NOTES:

P0 DRAWN

KJ 05/10/16

REV: DESCRIPTION:

BY: DATE:

STATUS: Preliminary - not for construction

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{ your tagline }

INTEGRATOR:
[your brand]
100 Your Road,
Your Town., YT1 1YT.

CLIENT:


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TITLE:

Cabling Information

SCALE: 1:1 @ A1 DATE: 05/10/2016 DRAWN: KJ CHECKED: KA

PROJECT NO: YB-02-C DRAWING NO: 2/14 REVISION: P0

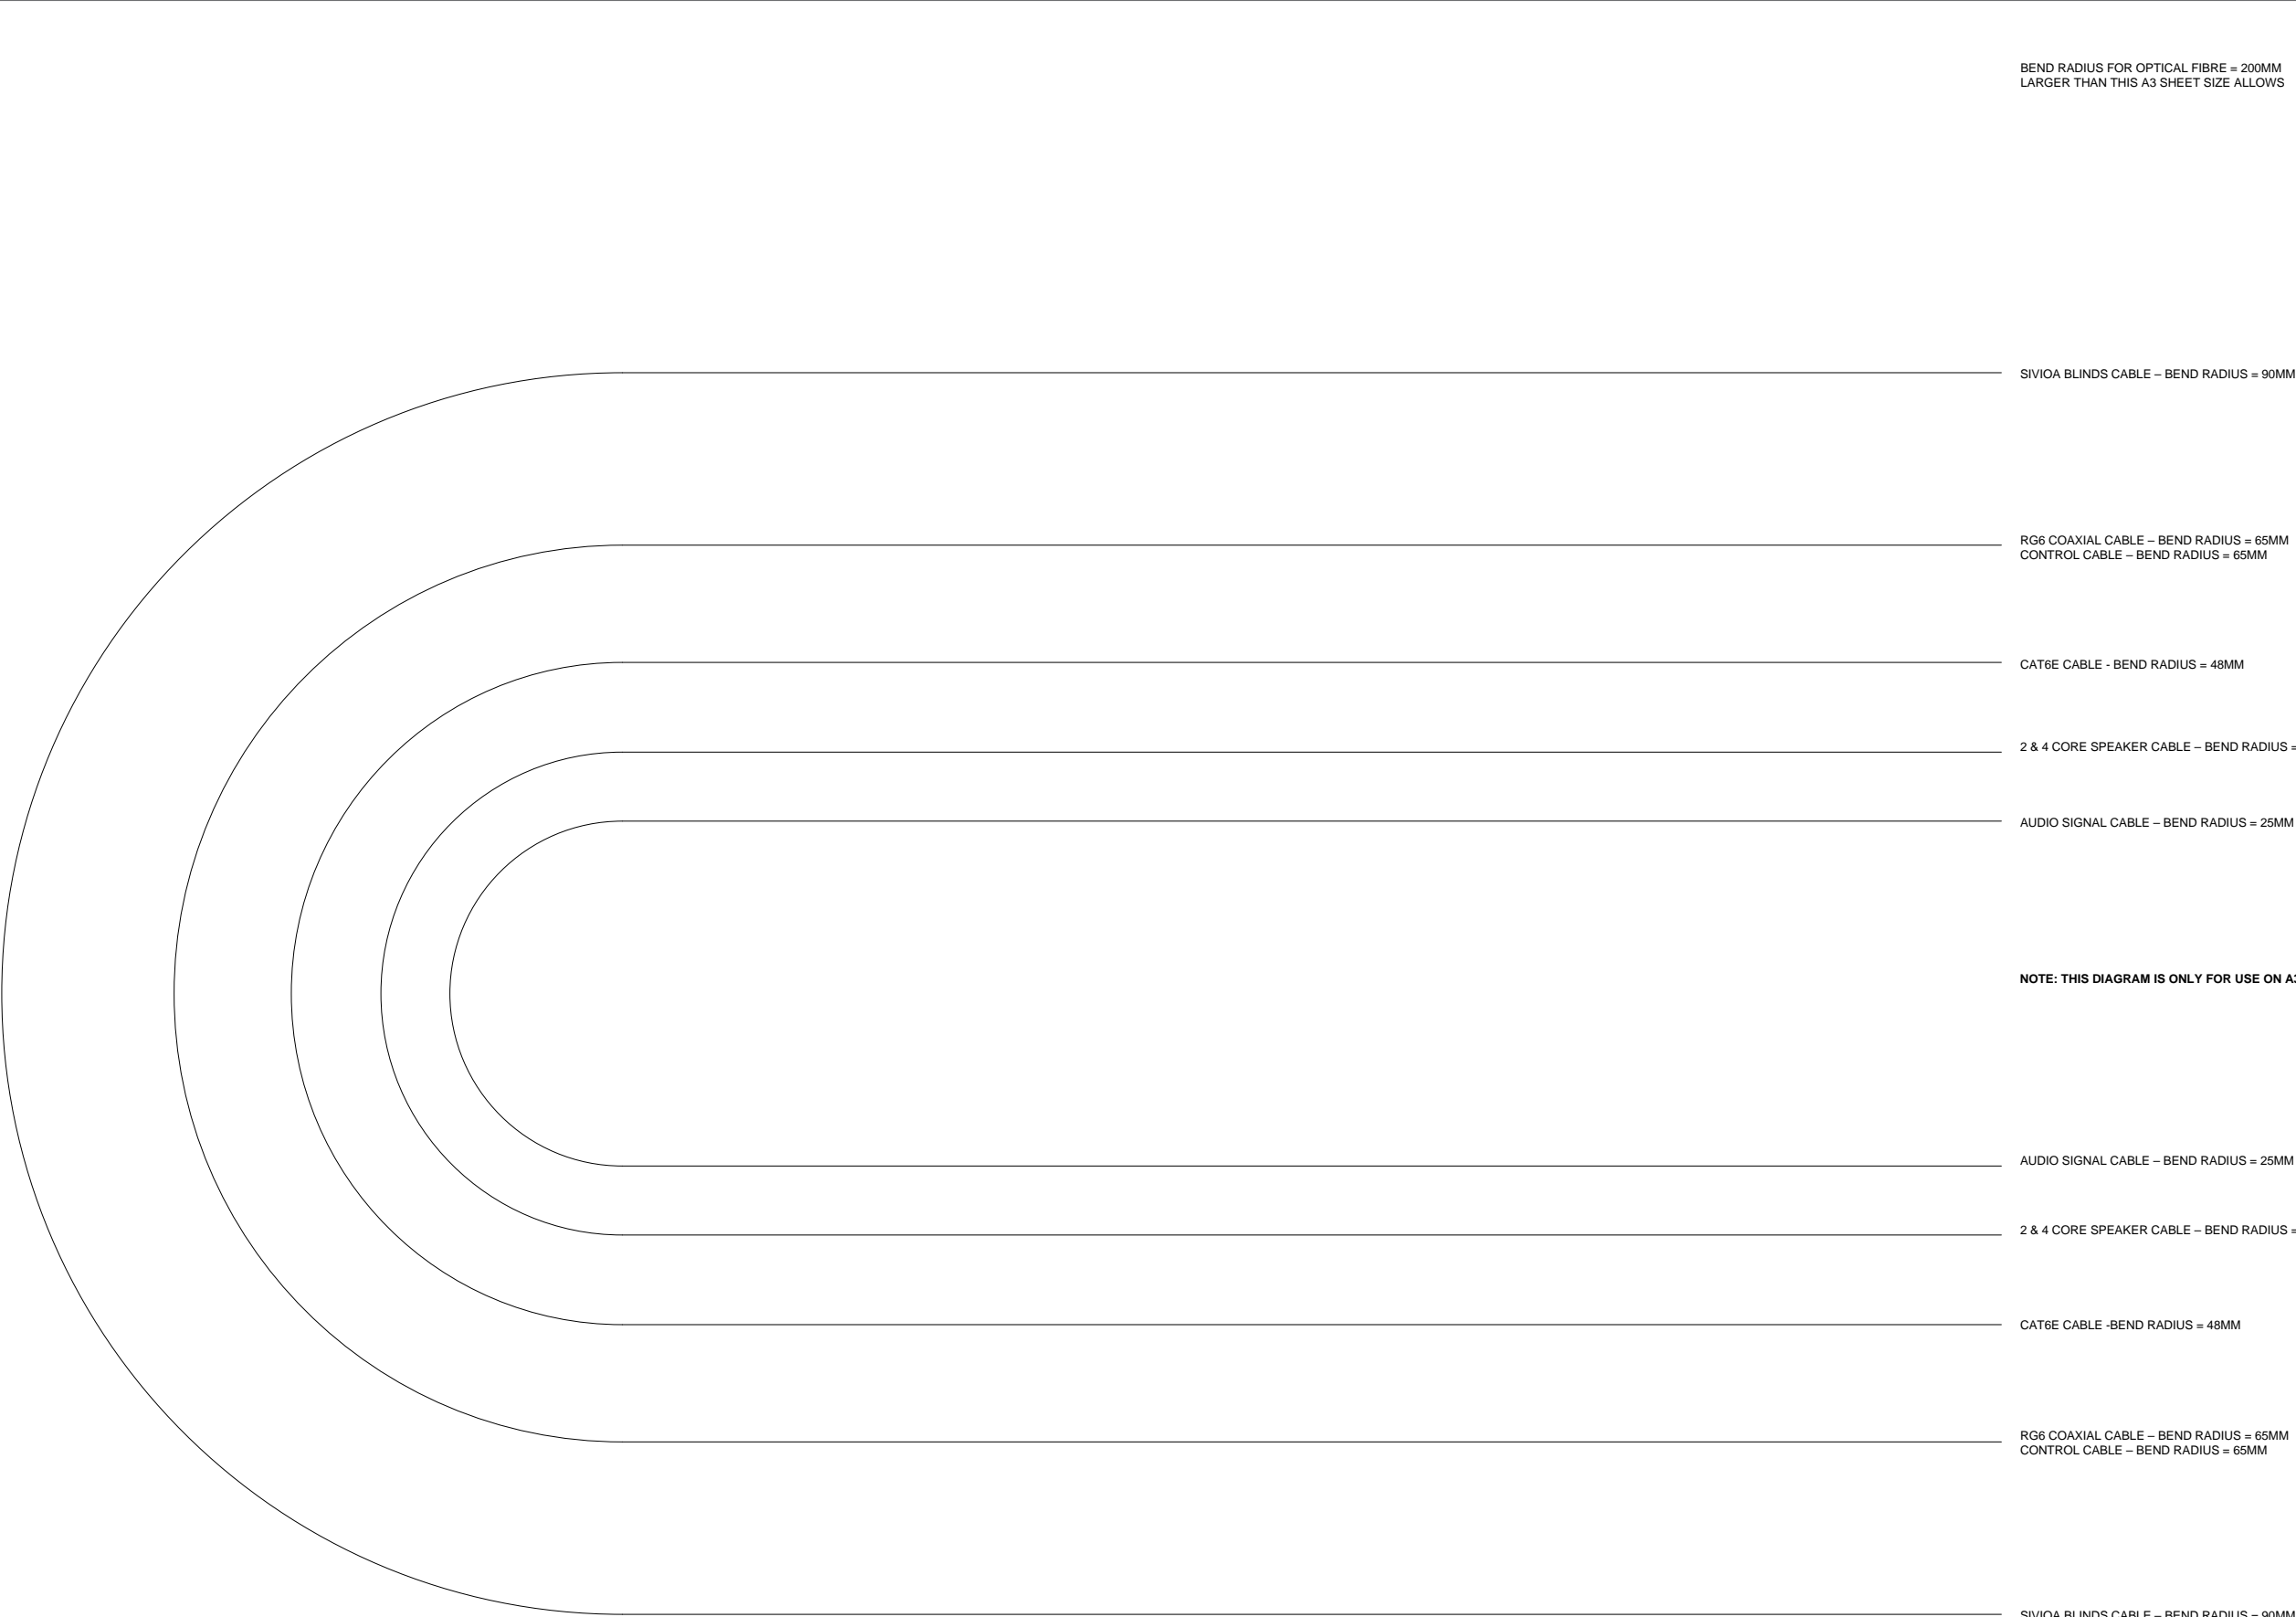

NOTES:

P0

DRAWN

KJ

05/10/16

REV:	DESCRIPTION:	BY:	DATE:
STATUS: Preliminary - not for construction			
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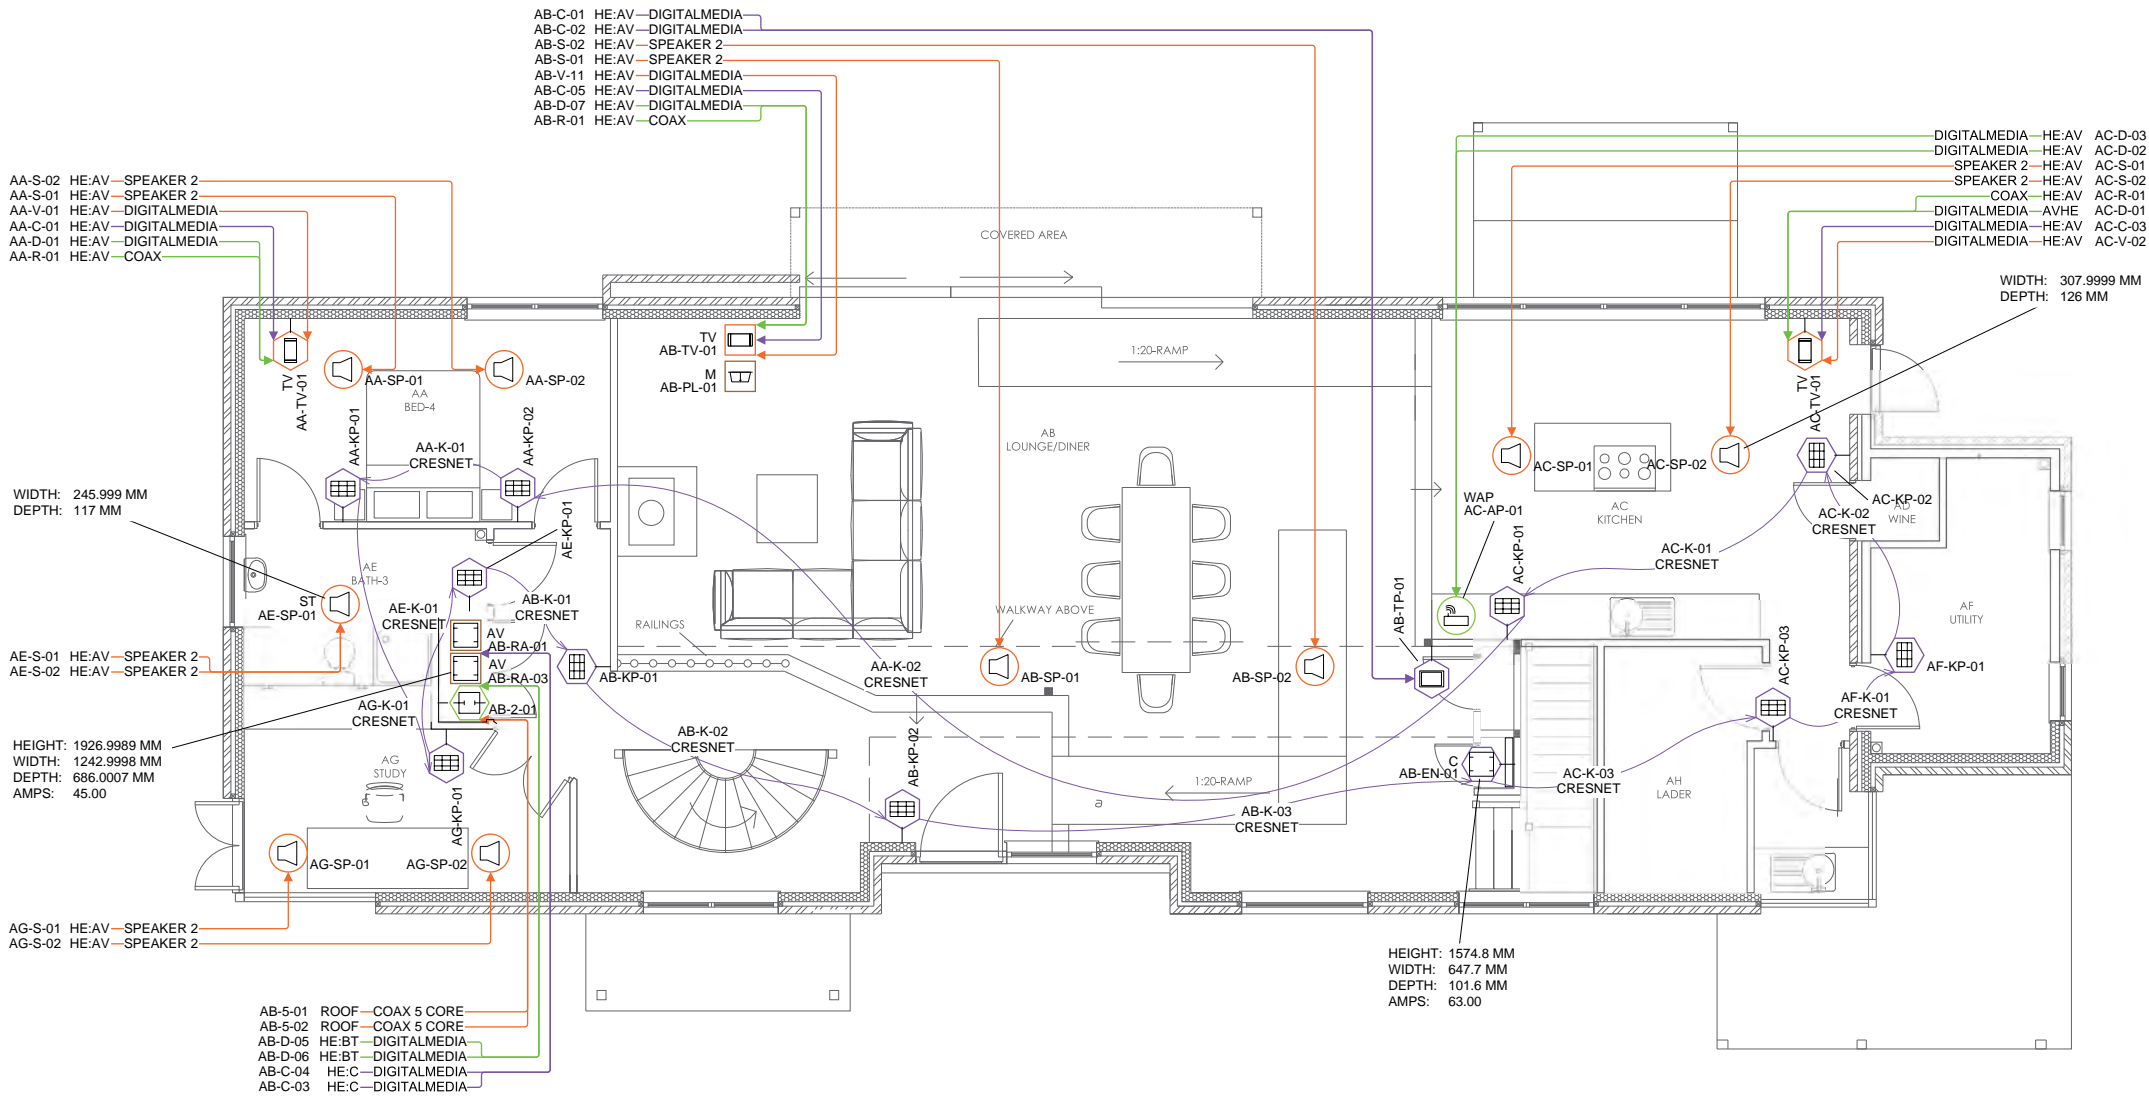
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Your Town., YT1 1YT.





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
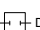

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

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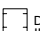
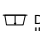
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PROJECT NO: YB-02-C	DRAWING NO: 3/14	REVISION: P0	







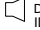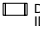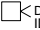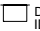


AUDIO VIDEO SYMBOLS		
SYMBOL	NAME	DO=DEVICE OPTIONS
 DO ID	SPEAKER	LCR-LCR BAR S-SUBWOOFER ST-STEREO
 DO ID	VIDEO DISPLAY	M-MIRROR TV WP-WEATHERPROOF TV
 DO ID	VIDEO PROJECTOR	LCD-LIQUID CRYSTAL DISPLAY DLP-DIGITAL LIGHT PROCESOR LED-LIGHT EMITTING DIODE
 DO ID	PROJECTION SCREEN	F-FIXED M-MOTORISED

COMMUNICATIONS SYMBOLS		
SYMBOL	NAME	DO=DEVICE OPTIONS
 DO ID	PHONE AND DATA PORT	D-DATA F-FIBRE OPTIC P-PHONE
 DO ID	INCOMING SERVICES	CTV-CABLE TV P-PHONE S-SATELLITE
 DO ID	RF REPEATER ACCESS POINT	CR-CELLULAR PR-PHONE WAP-WIRELESS ACCESS POINT

CONTROL SYMBOLS		
SYMBOL	NAME	DO=DEVICE OPTIONS
 DO ID	KEYPAD	M-MASTER WLS-WIRELESS
 DO ID	TOUCH PANEL	FT-FLIP TOP WLS-WIRELESS

FURNISHINGS SYMBOLS		
SYMBOL	NAME	DO=DEVICE OPTIONS
 DO ID	RACK OR HEAD END	AV-AUDIO/VIDEO C-CONTROL D-DATA SEC-SECURITY
 DO ID	LIFT/MOUNT	A-ARTICULATED M-MOTORISED UB-UNDER BED

MOUNTING OPTIONS		
	CEILING MOUNTED	MOUNTED ON CEILING OR CUT INTO CEILING
	WALL MOUNTED	MOUNTED ON OR IN WALL HEIGHT AS INDICATED IN ELEVATIONS OR AS MARKED
	FLOOR MOUNTED	MOUNTED IN FLOOR OR FREESTANDING

EXAMPLES: SYMBOL + MOUNTING OPTION		
SYMBOL	NAME	MOUNT TYPE
 ID	SPEAKER	CEILING MOUNTED
 ID	SPEAKER	WALL MOUNTED
 ID	SPEAKER	FLOOR MOUNTED
 ID	PRE-WIRE SPEAKER	CEILING MOUNTED PRE-WIRE ONLY NO CUTOUT

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REV: DESCRIPTION: BY: DATE:
STATUS: Preliminary - not for construction
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[your tagline]


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100 Your Road,
Your Town., YT1 1YT.





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
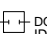

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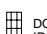

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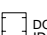
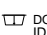
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PROJECT NO: YB-02-C	DRAWING NO: 4/14	REVISION: P0	


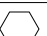




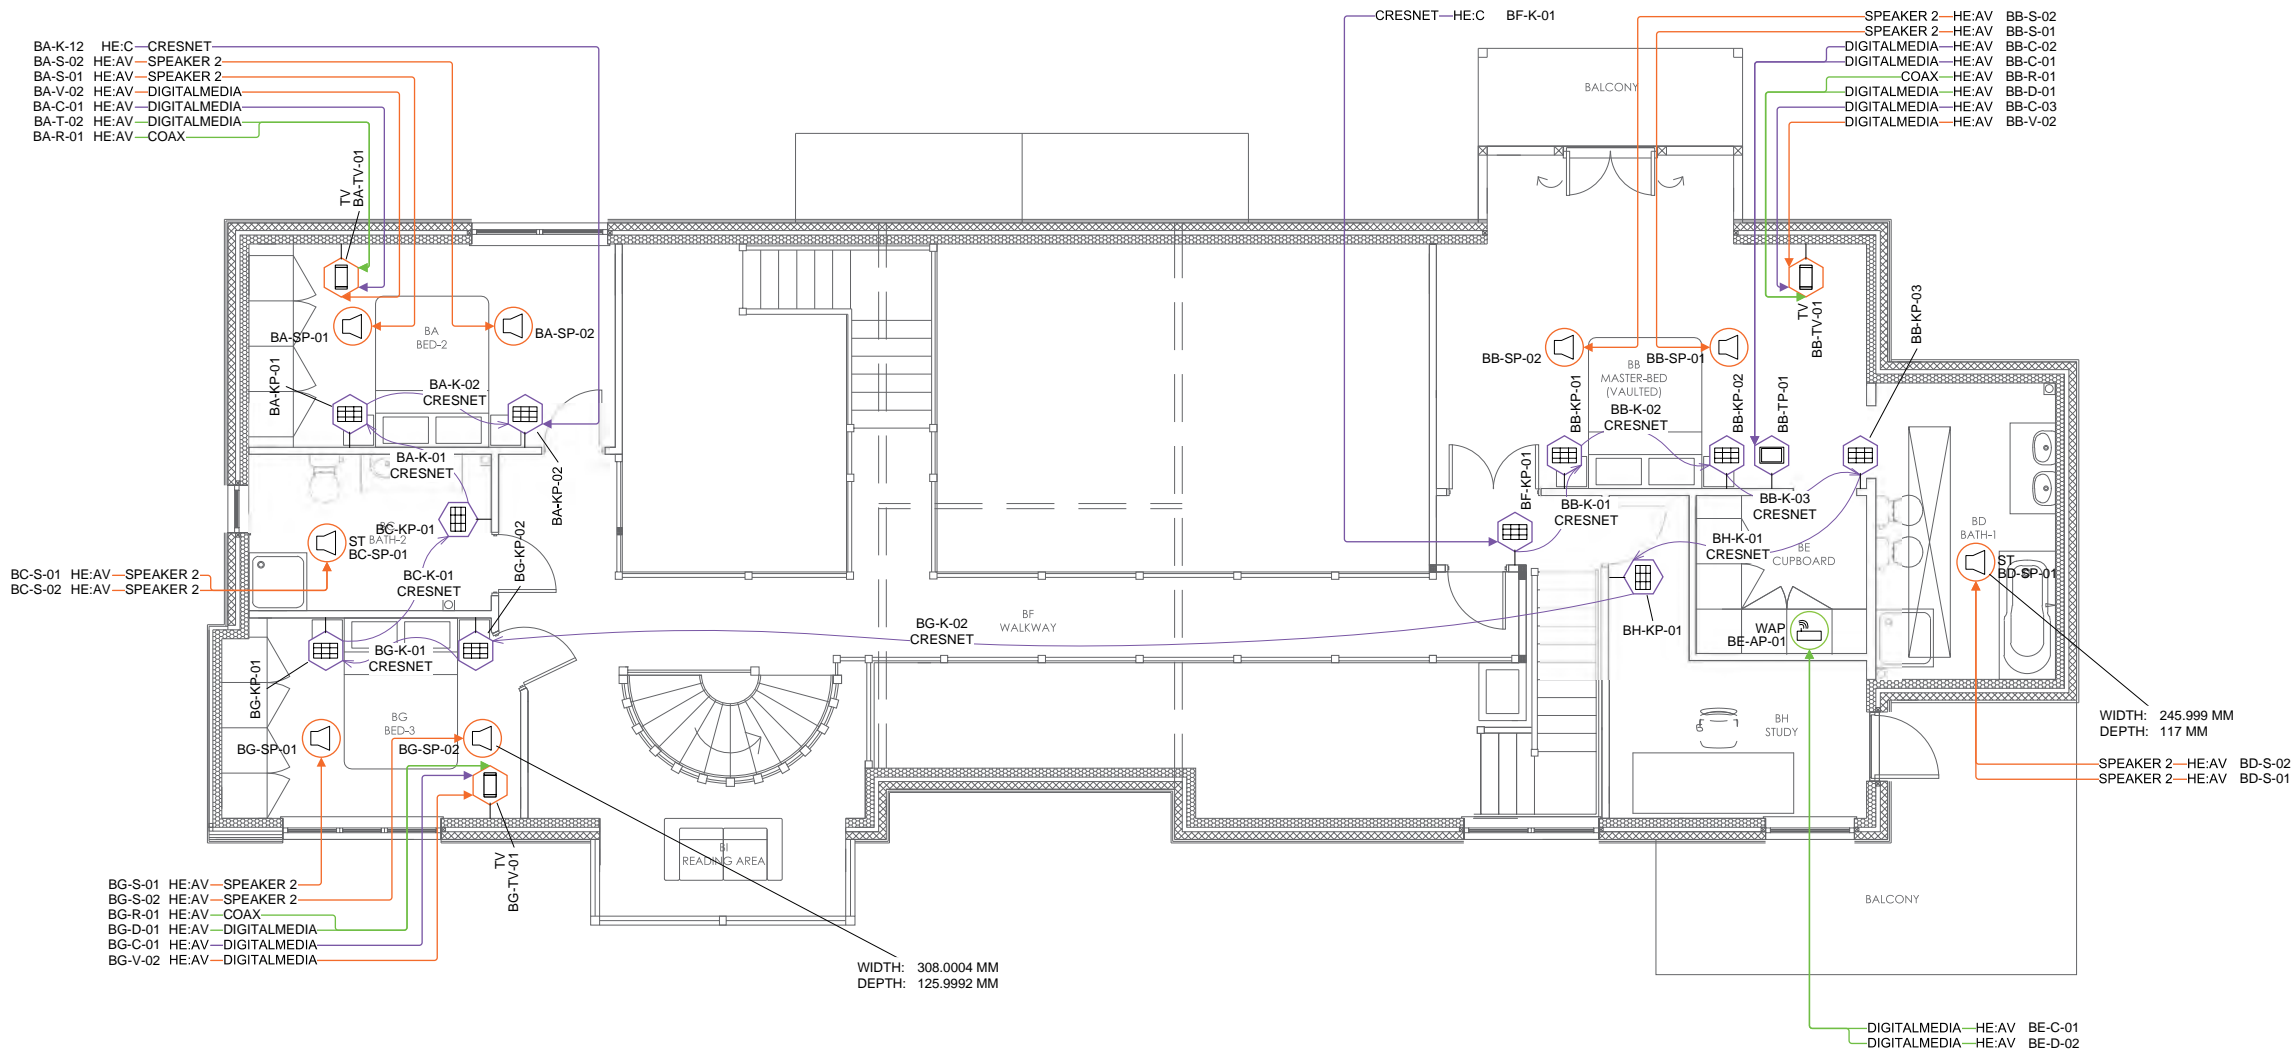


AUDIO VIDEO SYMBOLS		
SYMBOL	NAME	DO=DEVICE OPTIONS
	SPEAKER	LCR-LCR BAR S-SUBWOOFER ST-STEREO
	VIDEO DISPLAY	M-MIRROR TV WP-WEATHERPROOF TV
	VIDEO PROJECTOR	LCD-LIQUID CRYSTAL DISPLAY DLP-DIGITAL LIGHT PROCESSOR LED-LIGHT EMITTING DIODE
	PROJECTION SCREEN	F-FIXED M-MOTORISED

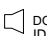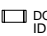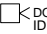COMMUNICATIONS SYMBOLS		
SYMBOL	NAME	DO=DEVICE OPTIONS
	PHONE AND DATA PORT	D-DATA F-FIBRE OPTIC P-PHONE
	INCOMING SERVICES	CTV-CABLE TV P-PHONE S-SATELLITE
	RF REPEATER ACCESS POINT	CR-CELLULAR PR-PHONE WAP-WIRELESS ACCESS POINT

CONTROL SYMBOLS		
SYMBOL	NAME	DO=DEVICE OPTIONS
	KEYPAD	M-MASTER WLS-WIRELESS
	TOUCH PANEL	FT-FLIP TOP WLS-WIRELESS

FURNISHINGS SYMBOLS		
SYMBOL	NAME	DO=DEVICE OPTIONS
	RACK OR HEAD END	AV-AUDIO/VIDEO C-CONTROL D-DATA SEC-SECURITY
	LIFT/MOUNT	A-ARTICULATED M-MOTORISED UB-UNDER BED

MOUNTING OPTIONS		
	CEILING MOUNTED	MOUNTED ON CEILING OR CUT INTO CEILING
	WALL MOUNTED	MOUNTED ON OR IN WALL HEIGHT AS INDICATED IN ELEVATIONS OR AS MARKED
	FLOOR MOUNTED	MOUNTED IN FLOOR OR FREESTANDING

EXAMPLES: SYMBOL + MOUNTING OPTION		
SYMBOL	NAME	MOUNT TYPE
	SPEAKER	CEILING MOUNTED
	SPEAKER	WALL MOUNTED
	SPEAKER	FLOOR MOUNTED
	PRE-WIRE SPEAKER	CEILING MOUNTED PRE-WIRE ONLY NO CUTOUT

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STATUS: Preliminary - not for construction
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[your tagline]


INTEGRATOR:
[your brand]
100 Your Road,
Your Town., YT1 1YT.





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
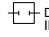

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

TITLE:
Plans First Floor - B

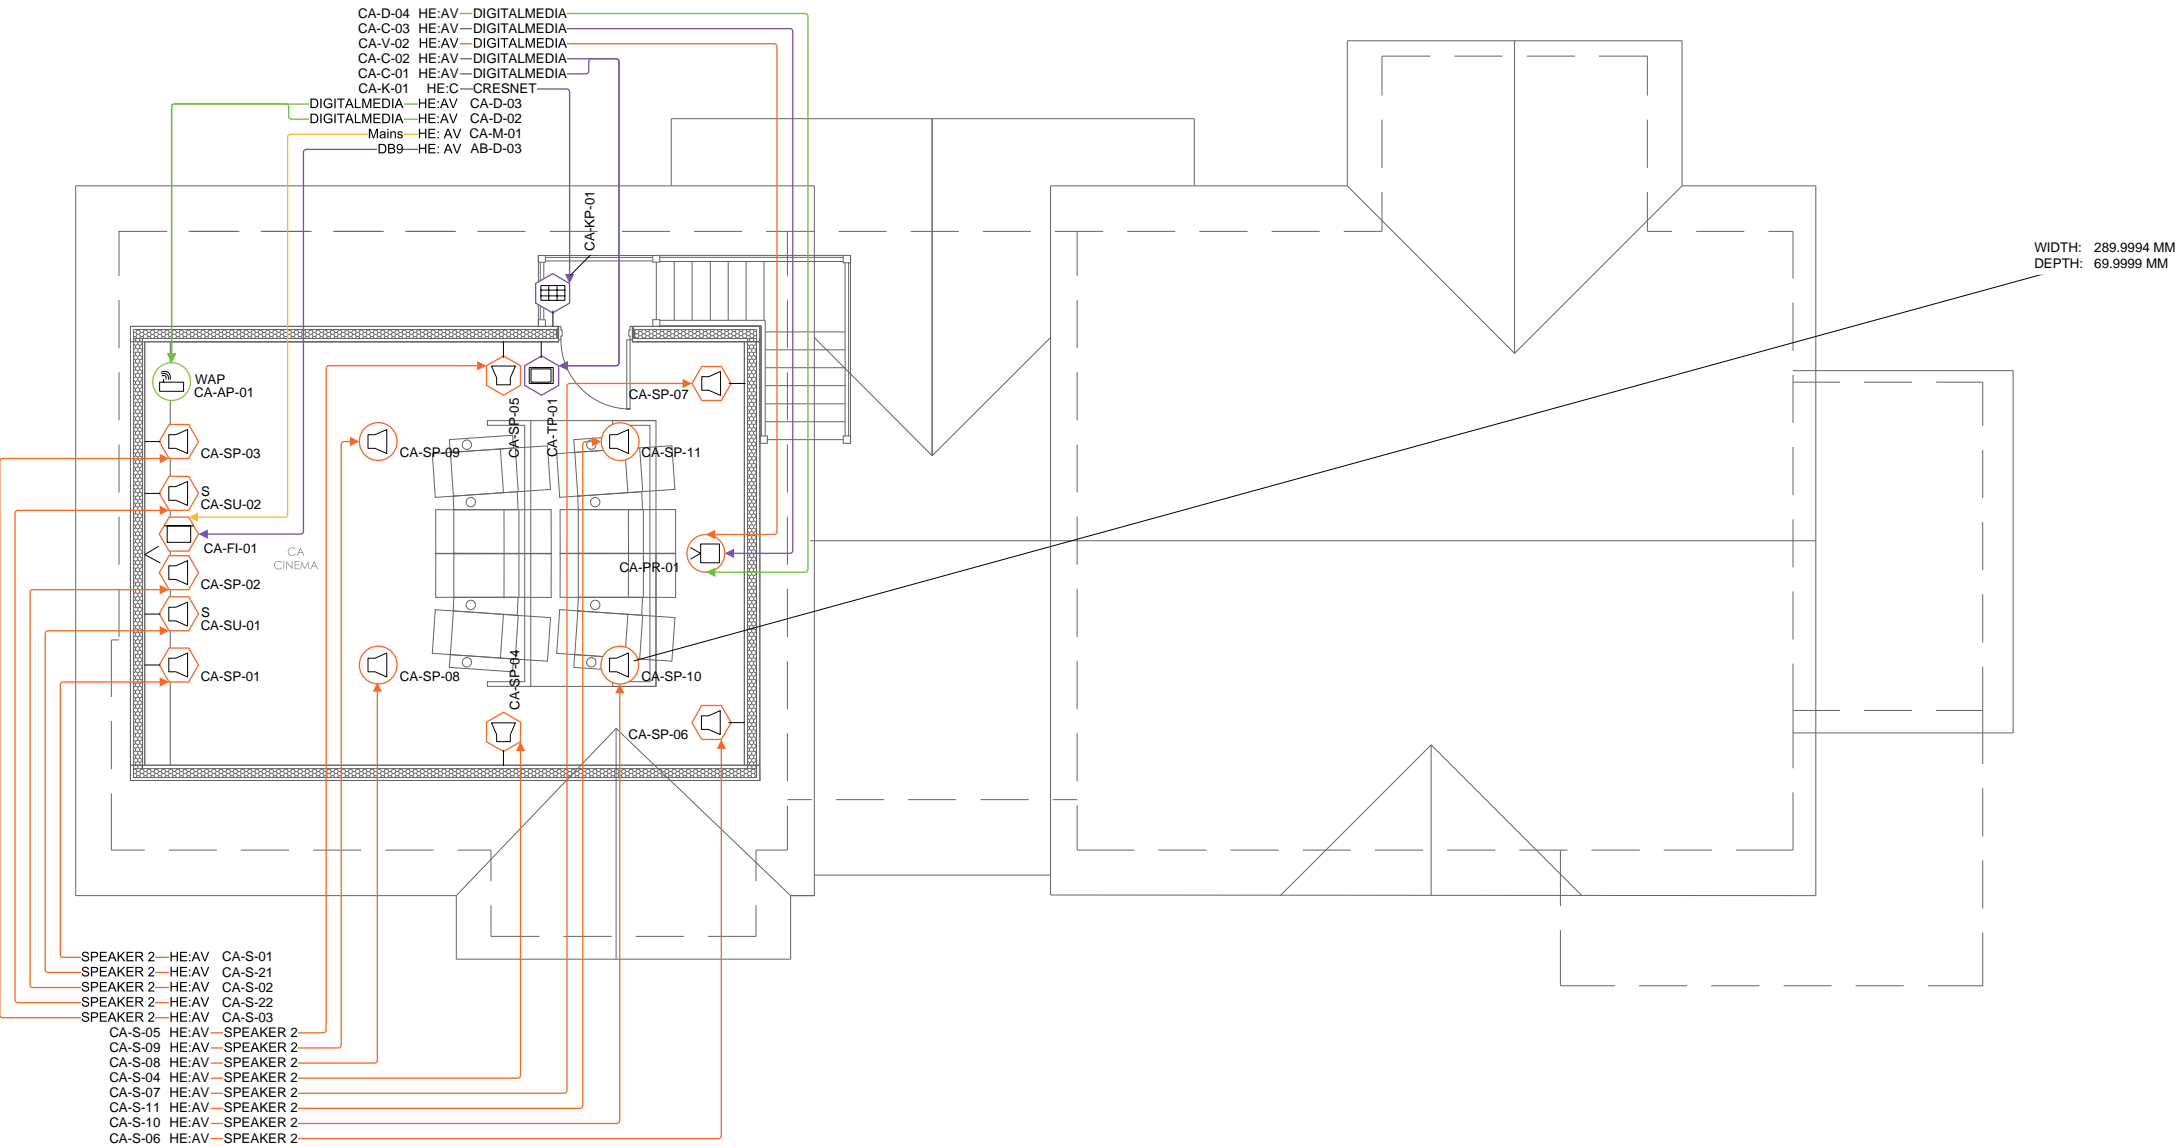

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PROJECT NO: YB-02-C	DRAWING NO: 5/14	REVISION: P0	


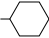







AUDIO VIDEO SYMBOLS		
SYMBOL	NAME	DO=DEVICE OPTIONS
 DO ID	SPEAKER	LCR-LCR BAR S-SUBWOOFER ST-STEREO
 DO ID	VIDEO DISPLAY	M-MIRROR TV WP-WEATHERPROOF TV
 DO ID	VIDEO PROJECTOR	LCD-LIQUID CRYSTAL DISPLAY DLP-DIGITAL LIGHT PROCESOR LED-LIGHT EMITTING DIODE
 DO ID	PROJECTION SCREEN	F-FIXED M-MOTORISED

COMMUNICATIONS SYMBOLS		
SYMBOL	NAME	DO=DEVICE OPTIONS
 DO ID	PHONE AND DATA PORT	D-DATA F-FIBRE OPTIC P-PHONE
 DO ID	INCOMING SERVICES	CTV-CABLE TV P-PHONE S-SATELLITE
 DO ID	RF REPEATER ACCESS POINT	CR-CELLUAR PR-PHONE WAP-WIRELESS ACCESS POINT

CONTROL SYMBOLS		
SYMBOL	NAME	DO=DEVICE OPTIONS
 DO ID	KEYPAD	M-MASTER WLS-WIRELESS
 DO ID	TOUCH PANEL	FT-FLIP TOP WLS-WIRELESS

FURNISHINGS SYMBOLS		
SYMBOL	NAME	DO=DEVICE OPTIONS
 DO ID	RACK OR HEAD END	AV-AUDIO/VIDEO C-CONTROL D-DATA SEC-SECURITY
 DO ID	LIFT/MOUNT	A-ARTICULATED M-MOTORISED UB-UNDER BED

MOUNTING OPTIONS		
 CEILING MOUNTED	CEILING MOUNTED	MOUNTED ON CEILING OR CUT INTO CEILING
 WALL MOUNTED	WALL MOUNTED	MOUNTED ON OR IN WALL HEIGHT AS INDICATED IN ELEVATIONS OR AS MARKED
 FLOOR MOUNTED	FLOOR MOUNTED	MOUNTED IN FLOOR OR FREESTANDING

EXAMPLES: SYMBOL + MOUNTING OPTION		
SYMBOL	NAME	MOUNT TYPE
 ID	SPEAKER	CEILING MOUNTED
 ID	SPEAKER	WALL MOUNTED
 ID	SPEAKER	FLOOR MOUNTED
 ID	PRE-WIRE SPEAKER	CEILING MOUNTED PRE-WIRE ONLY NO CUTOUT

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STATUS: Preliminary - not for construction
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{ your tagline }


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[your brand]
100 Your Road,
Your Town., YT1 1YT.

CLIENT:

SITE:

TITLE:
Plans Loft - C

SCALE: 1:50 @A1	DATE: 05/10/2016	DRAWN: KJ	CHECKED: KA
PROJECT NO: YB-02-C	DRAWING NO: 6/14	REVISION: P0	

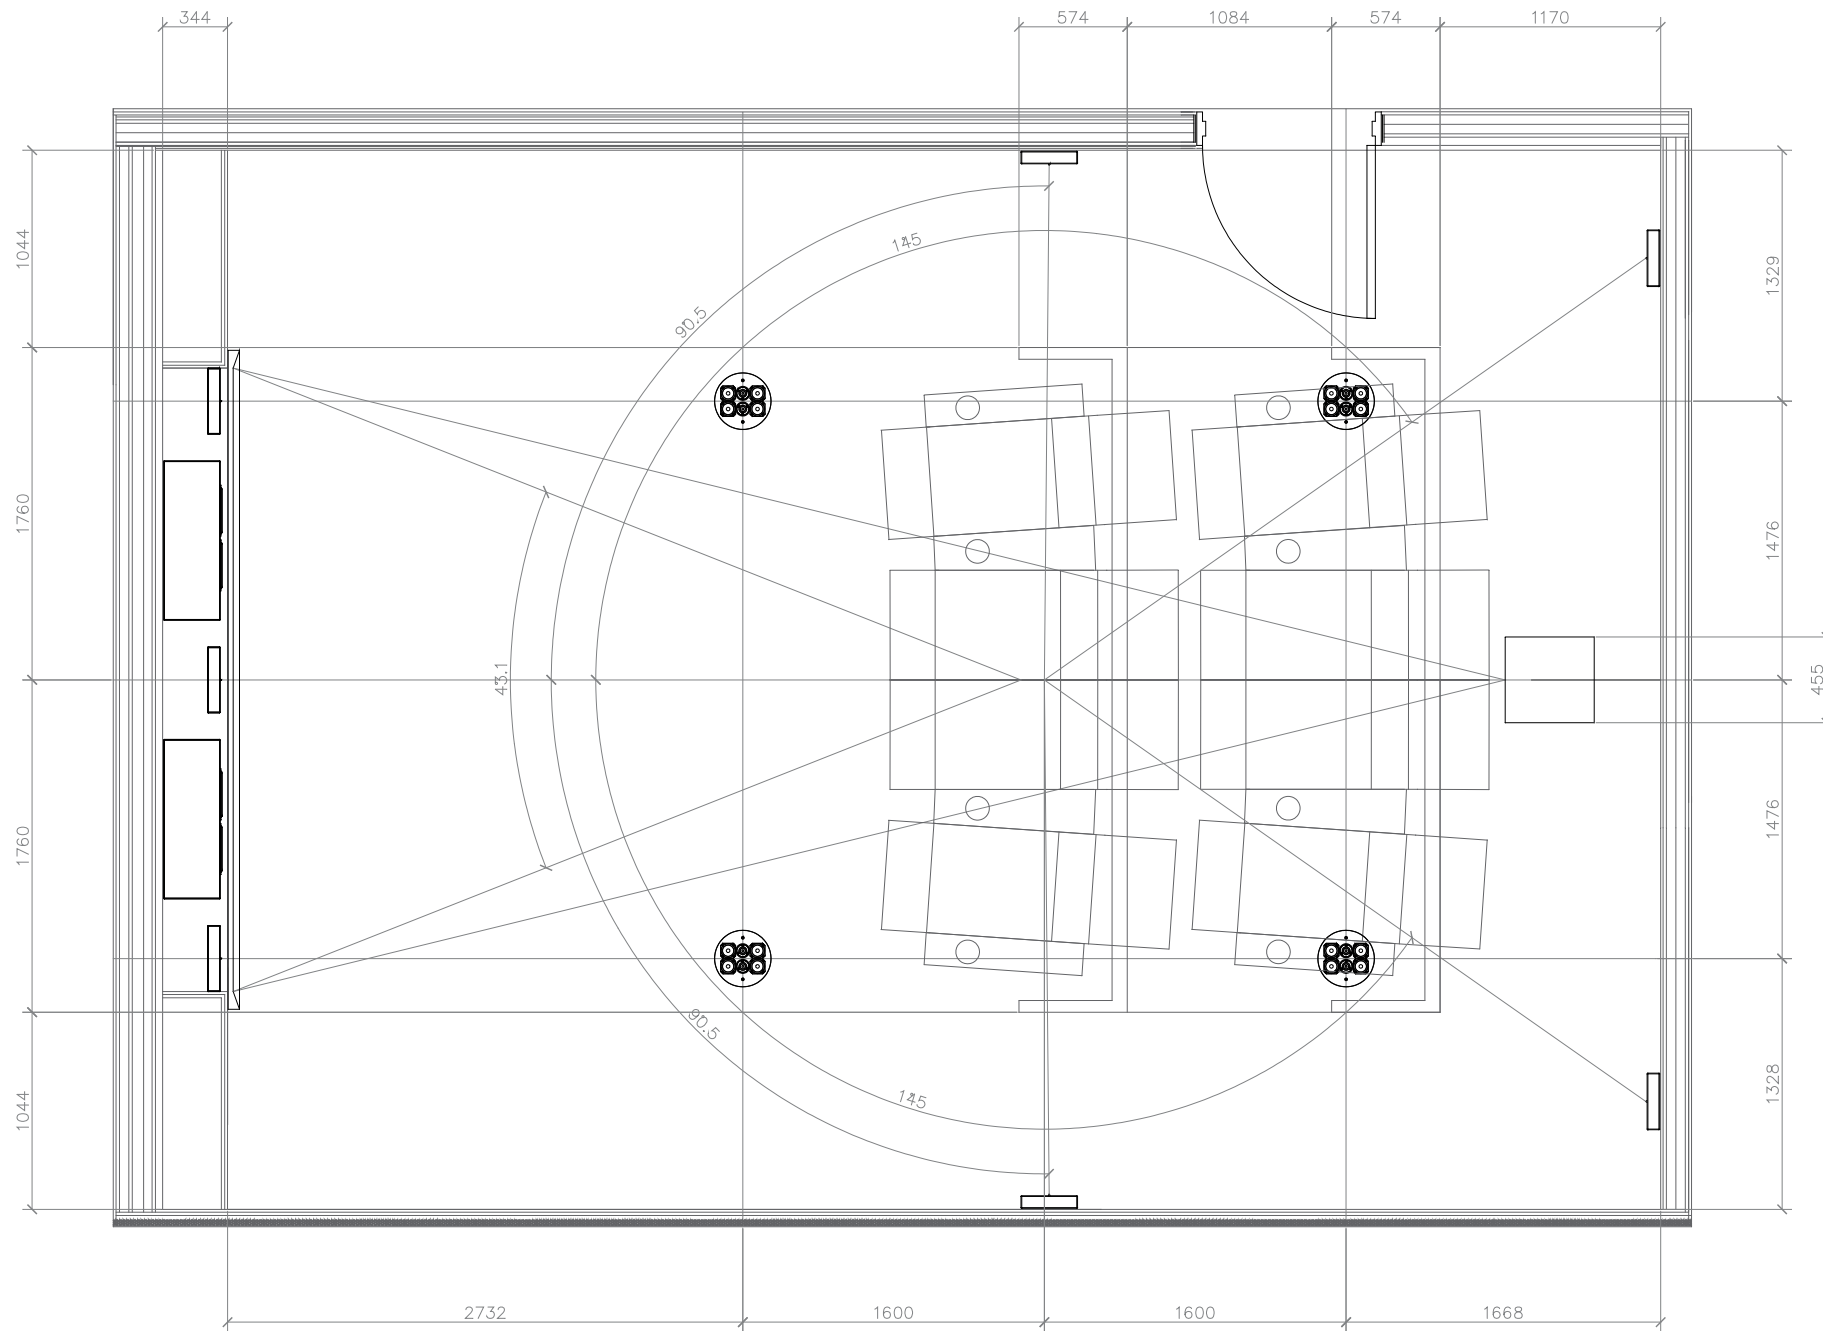

ROOM DIMENSIONS L 7600 X W 5600 X H 2800 APPROX.

NOTES:

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STATUS: Preliminary - not for construction

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[your brand]

{ your tagline }

INTEGRATOR:
[your brand]
100 Your Road,
Your Town., YT1 1YT.

CLIENT:

SITE:


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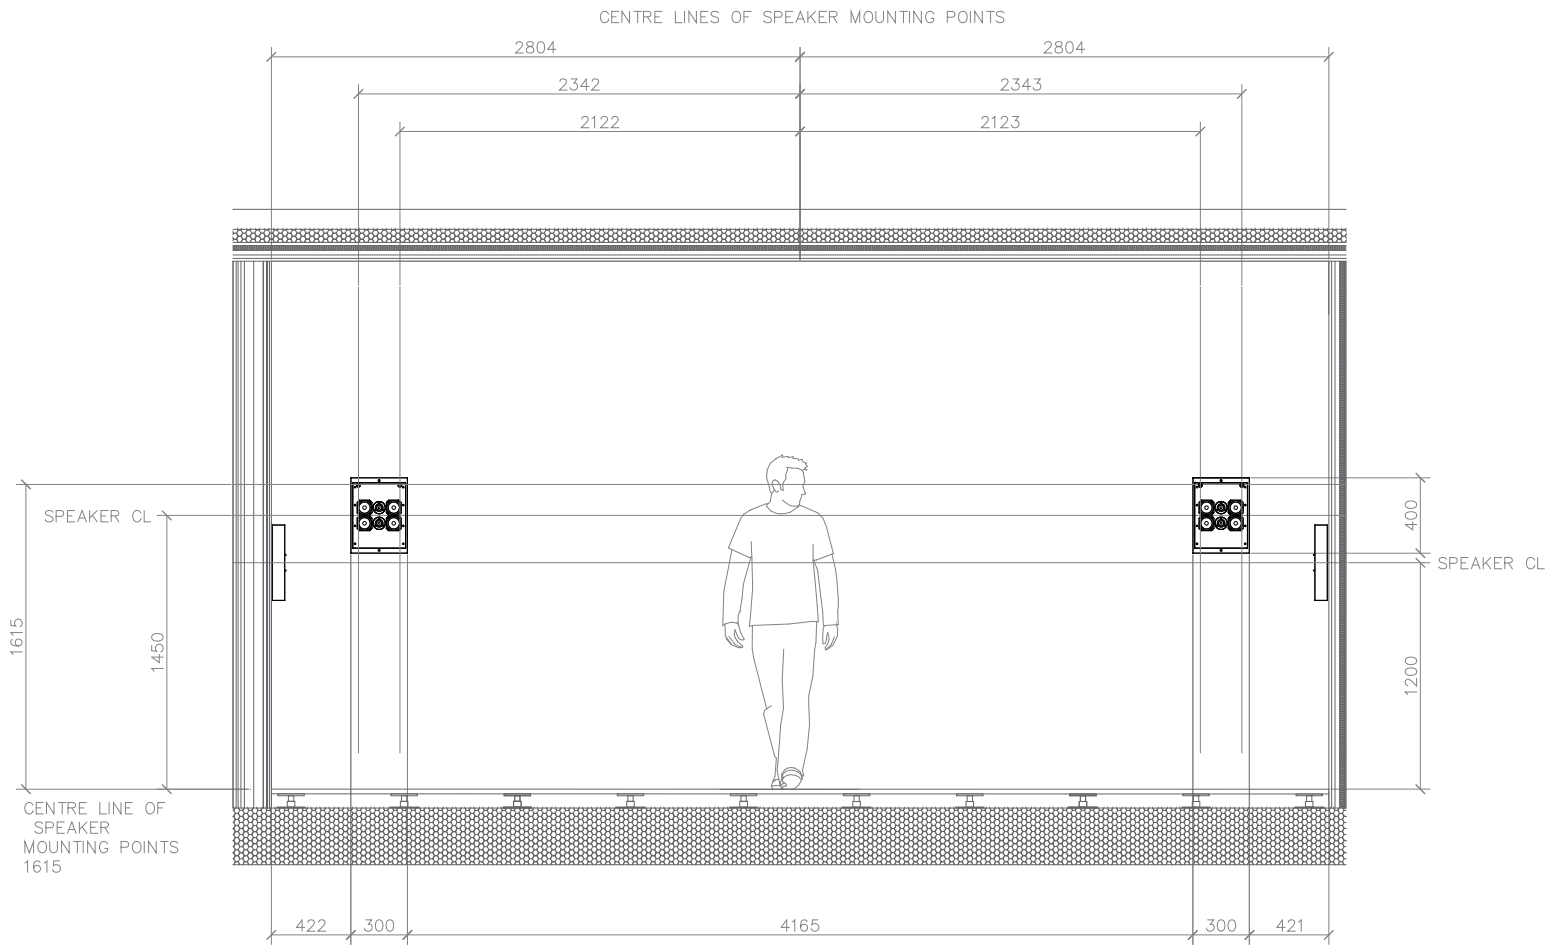
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PROJECT NO: YB-02-C	DRAWING NO: 7/14	REVISION: P0	

CLIENT:

TITLE: Elevations Cinema Screen Wall

SCALE: 1:20@A1	DATE: 05/10/2016	DRAWN: KJ	CHECKED: KA
PROJECT NO: YB-02-C	DRAWING NO: 8/14		REVISION: P0



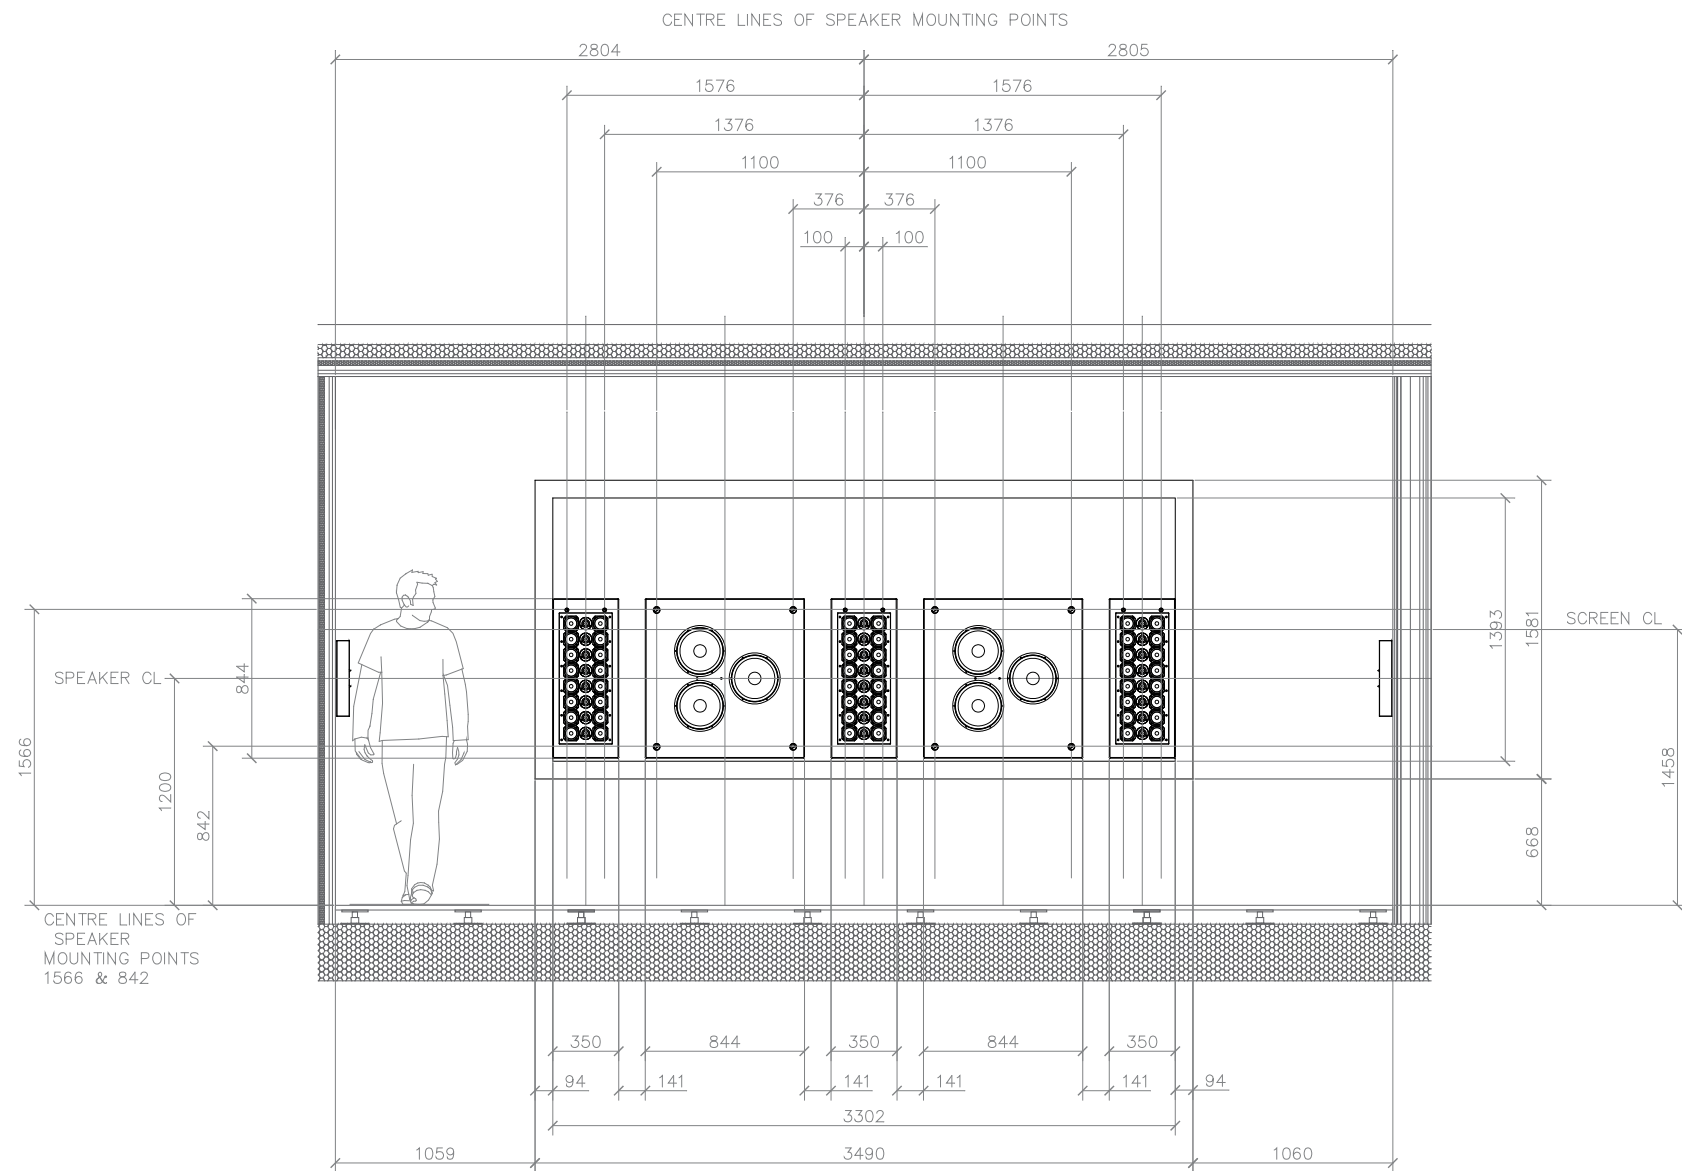

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[your brand]
{ your tagline }

INTEGRATOR:
[your brand]
100 Your Road,
Your Town., YT1 1YT.


CLIENT:

SITE:

TITLE:
Elevations Cinema Rear Wall

SCALE: 1:20 @A1	DATE: 05/10/2016	DRAWN: KJ	CHECKED: KA
PROJECT NO: YB-02-C	DRAWING NO: 9/14	REVISION: P0	

NOTES:

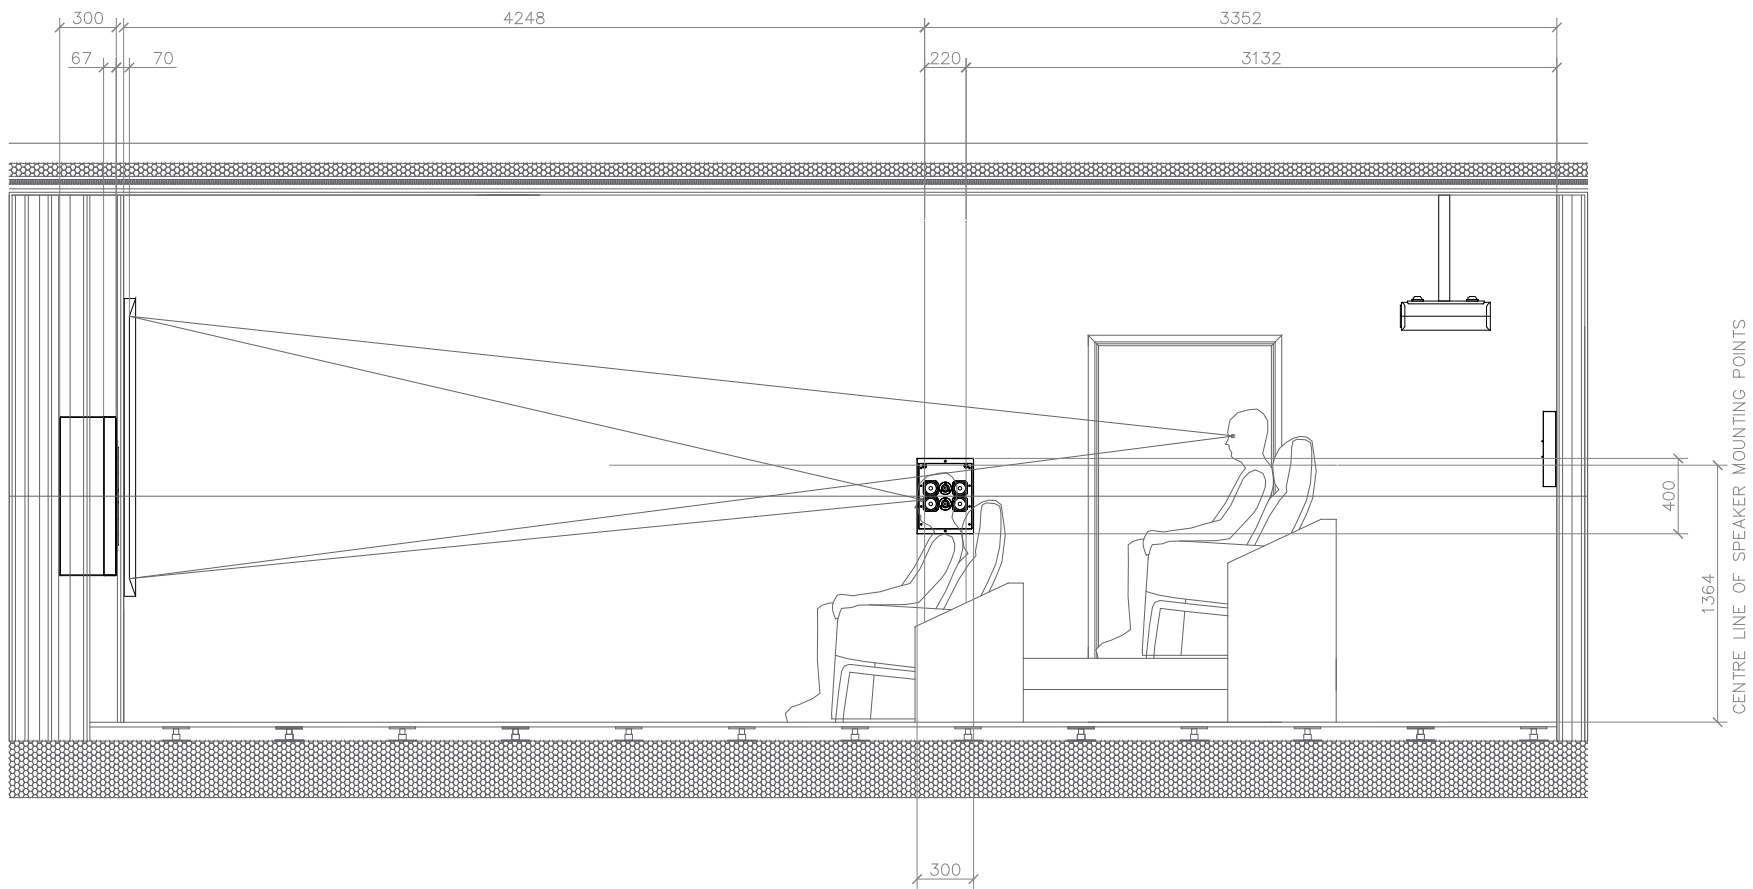

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REV: DESCRIPTION: BY: DATE:

STATUS: Preliminary - not for construction

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{ your tagline }


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[your brand]
100 Your Road,
Your Town., YT1 1YT.

CLIENT:

SITE:

TITLE:
Elevations Cinema Right Wall

SCALE: 1:20 @A1	DATE: 05/10/2016	DRAWN: KJ	CHECKED: KA
PROJECT NO: YB-02-C	DRAWING NO: 10/14	REVISION: P0	

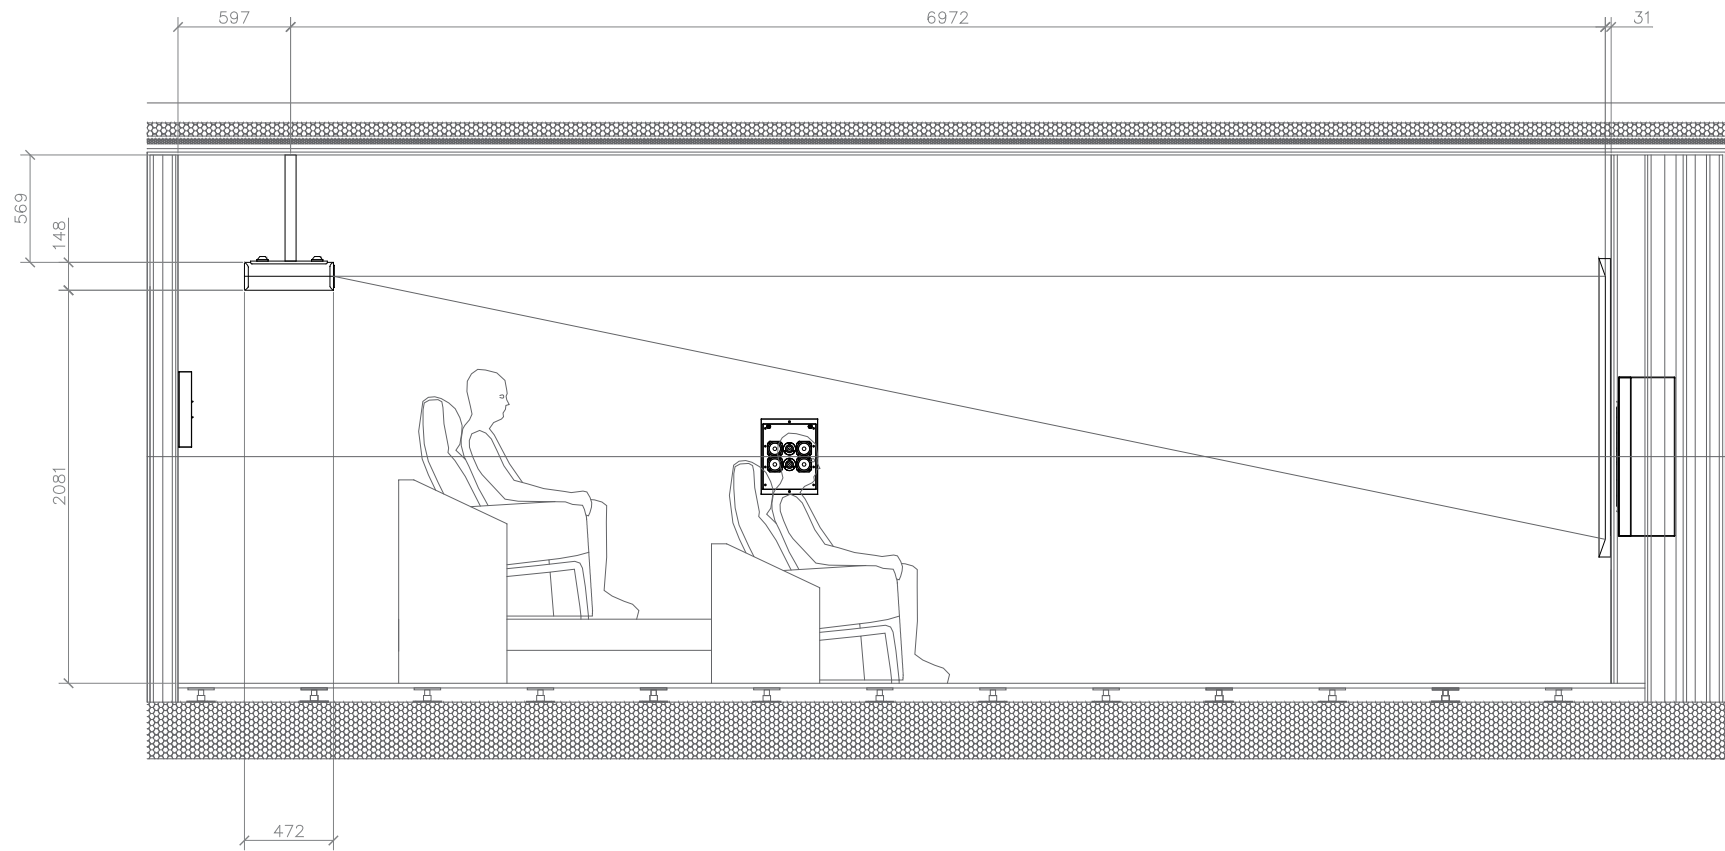

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REV: DESCRIPTION: BY: DATE:

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{ your tagline }


INTEGRATOR:
[your brand]
100 Your Road,
Your Town., YT1 1YT.

CLIENT:

SITE:

TITLE:
Elevations Cinema Left Wall

SCALE: 1:20 @A1	DATE: 05/10/2016	DRAWN: KJ	CHECKED: KA
PROJECT NO: YB-02-C	DRAWING NO: 11/14	REVISION: P0	

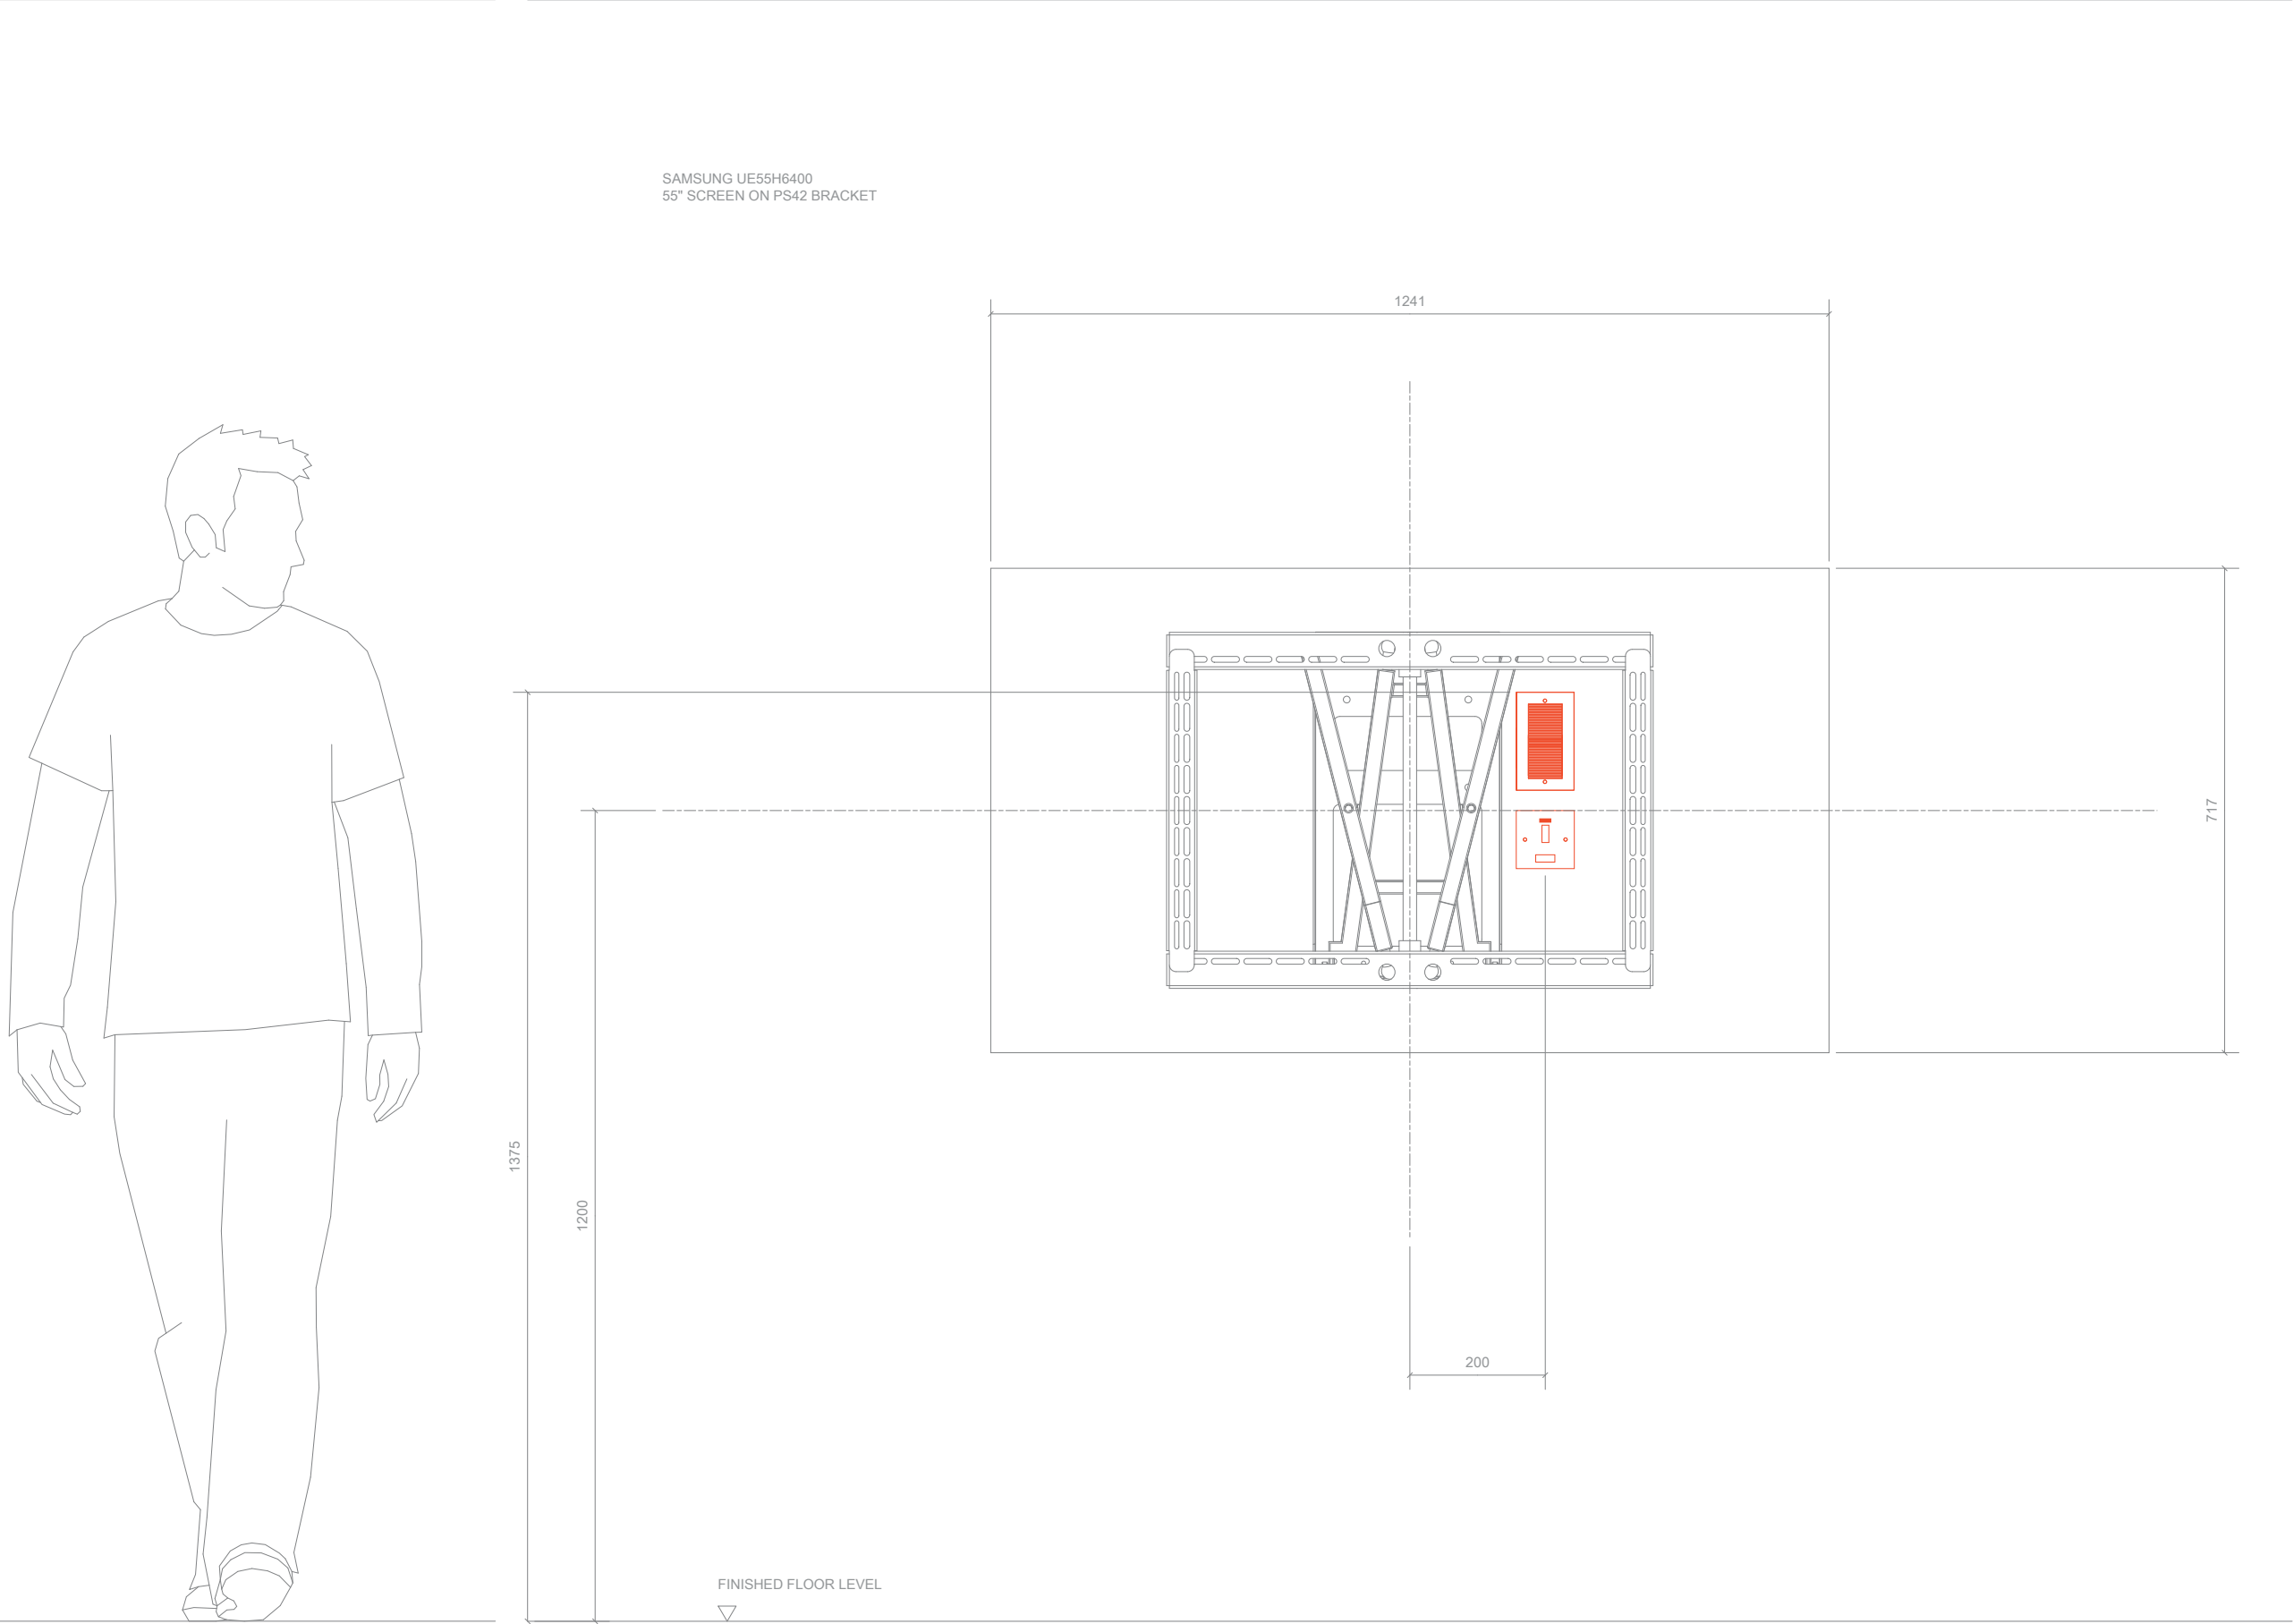

NOTES:

P0	DRAWN	KJ	05/10/16
REV:	DESCRIPTION:	BY:	DATE:
STATUS: Preliminary - not for construction			
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{ your tagline }


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100 Your Road,
Your Town., YT1 1YT.

CLIENT:


SITE:

TITLE:
**Elevations TV Kitchen, Master
Bed, Beds 2, 3 & 4**

SCALE:	DATE: 05/10/2016	DRAWN: KJ	CHECKED: KA
PROJECT NO: YB-02-C	DRAWING NO: 12/14	REVISION: P0	

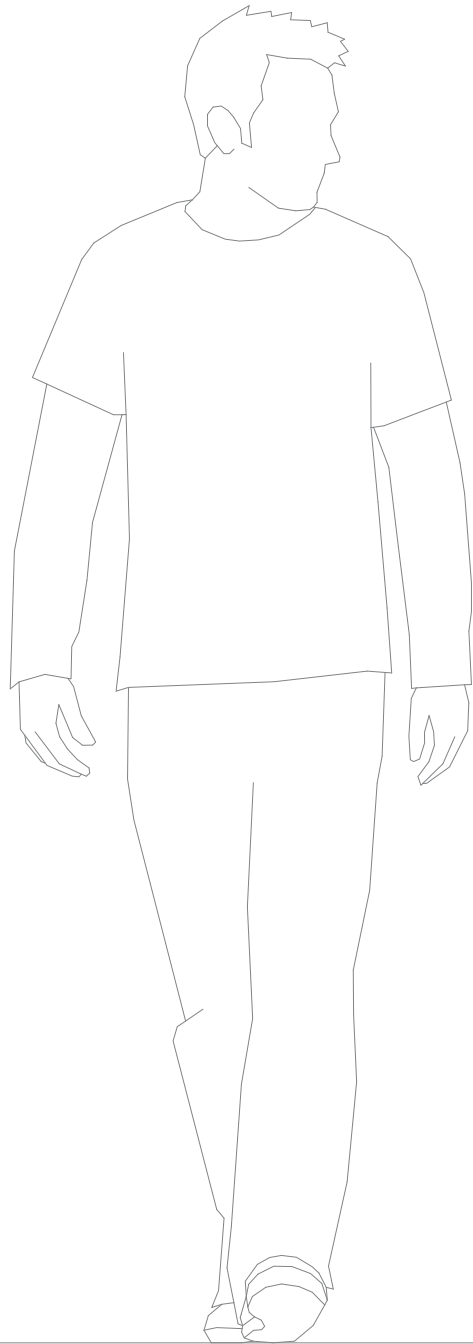


LIGHT CONTROLS CRESTRON C2NI-CB-B-T
BACK BOX 47MM DEEP SINGLE GANG UK

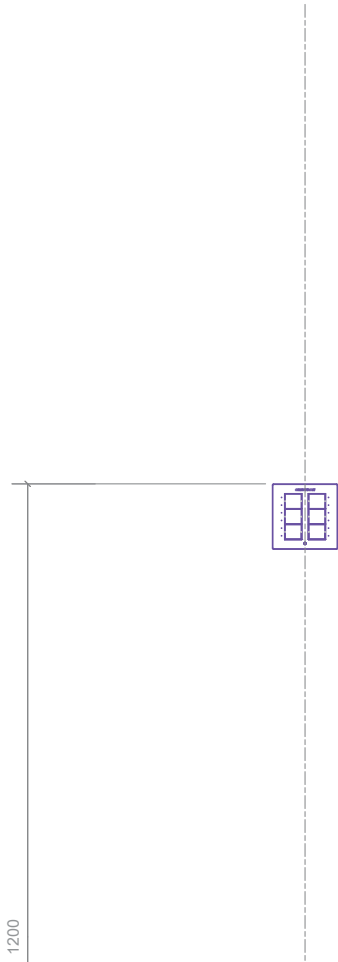

FINISHED FLOOR LEVEL



TOUCH PANEL TSW750
BACK BOX: CUSTOM

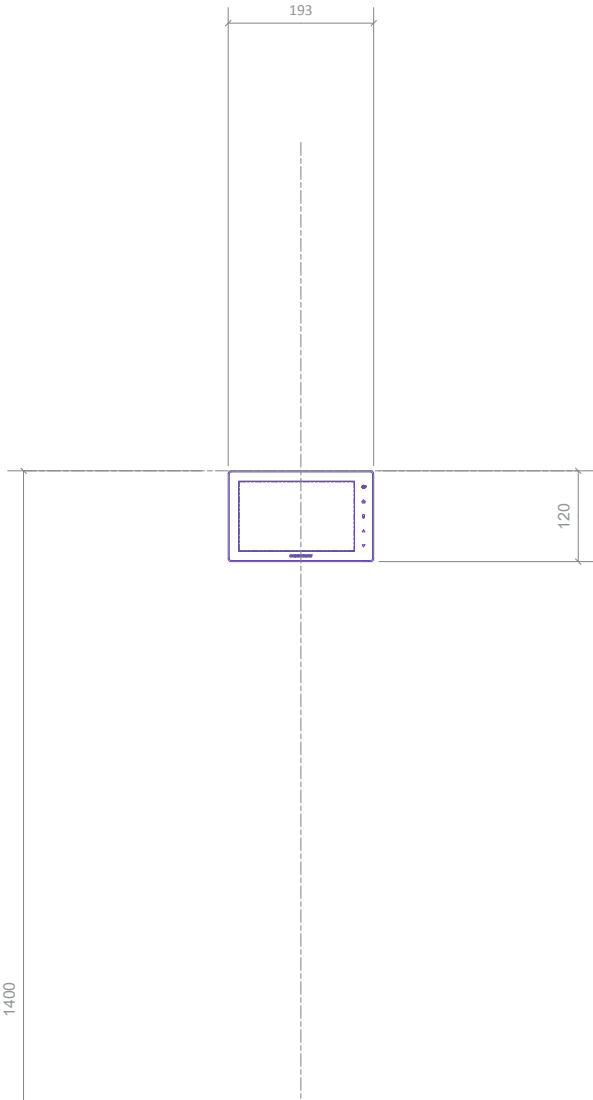

FINISHED FLOOR LEVEL



NOTES:

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REV:	DESCRIPTION:	BY:	DATE:
STATUS: Preliminary - not for construction			
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{ your tagline }

INTEGRATOR:
[your brand]
100 Your Road,
Your Town., YT1 1YT.

CLIENT:

SITE:

TITLE: Elevations Touch Panel, Light Switches

SCALE:	DATE: 05/10/2016	DRAWN: KJ	CHECKED: KA
PROJECT NO: YB-02-C	DRAWING NO: 13/14	REVISION: P0	



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[your brand]
{ your tagline }

INTEGRATOR:
[your brand]
100 Your Road,
Your Town., YT1 1YT.

CLIENT:

SITE:

TITLE:
Elevations Dimming Panel


SCALE:	DATE: 05/10/2016	DRAWN: KJ	CHECKED: KA
PROJECT NO: YB-02-C	DRAWING NO: 14/14	REVISION: P0	

[your brand]
[your tagline]

CEDIA[™] MEMBER

CRESTRON

ENGINEERING PACK, LAST REV: 05/10/2016

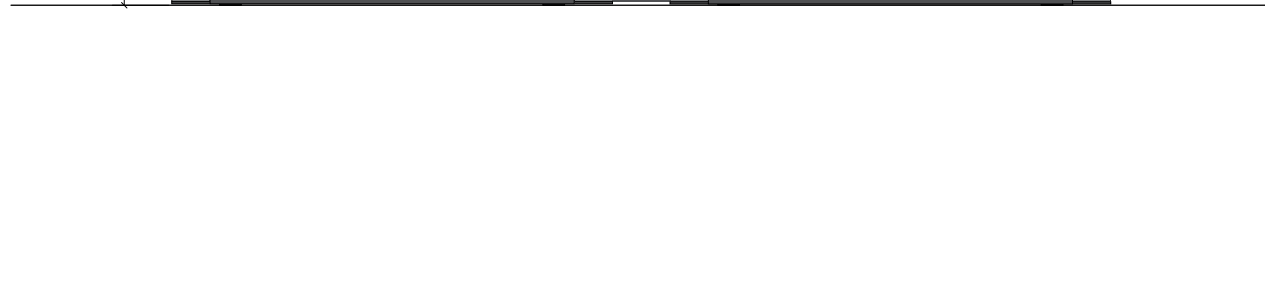



CEDIA MEMBER

INTEGRATOR:
[your brand]
100 Your Road,
Your Town., YT1 1YT.



CLIENT: _____

SITE: _____

TITLE: **Main Rack Left Build**

SCALE: 1:5@A1	DATE: 05/10/2016	DRAWN: KJ	CHECKED: KA
PROJECT NO: YB_02_C	DRAWING NO:		REVISION: P0

Model	Description	QTY	Total U	Total Watts	Total BTU	Total KG
Apc						
SMT1000RM2U	Smart UPS - 700 Watt/1000	1	2	1000	3413	28.18
Cisco						
867VAE	4-port 10/100 VDSL2/ADSL2+	1		60	204	2.5
Crestron						
CEN-SWPOE-24	24-port managed poe switch	2	4	920	800	3.72
DMC-HD-DSP	Hdmi input card w/down-mixing	4				0.92
DMCO-55	4 DM 8g+ with 2 hdmi output	2				
DM-MD8X8	High definition audio/video	1	4	300	750	9.1
ST-PC	Dual power control module,	4		24	81.88	4.6
ST-RMK	Rack mount kit for cresnet	2	2			1
Furman						
ELITE-16 PF I	Ultra-linear AC power source	1	2	2	7.85	8
Kaleidescape						
CINEMA ONE	Cinema one ultimate movie	1		90	310	10.9
DV700	Disc vault for housing and	1	5	46	160	22.23
Middle Atlantic						
BL1	1 space (1 3/4 in.) flanged	12	12			1.68
BGR-4127	Gangable rack enclosure	1				65.33
BGR-552FT-FC	Top option - fan top with	1				4.35
BGR-RR41	Threaded rackrail - pair	1				6.22
BSPN-41-27	Side panel	1				24
BVFD-41	Bgr series front door -vented	1				14.22
C	Clamp kit for rsh	4				1.8
CBS-BGR	Caster kit	1				7.78
HP500	Standard rack screw x 500	1				
MA-LBP-1A (SINGLE)	L shaped lacing bar, only	3				
MA-LBP-2A (SINGLE)	L shaped lacing bar, 50mm	1				
MA-LBP-4A (SINGLE)	L shaped lacing bar, 100mm	2				
MA-LBP-6A (SINGLE)	L shaped lacing bar, 150mm	8				
RSH4A2S	2 space custom rackmount	5	10			
VBK-BGR	Rear door vent strip	1				1.47
Sky						
AMSTRAD DRX890	High definition satellite receiver	3		135	470.85	6.9
Totals			41	2577	6197.58	224.9

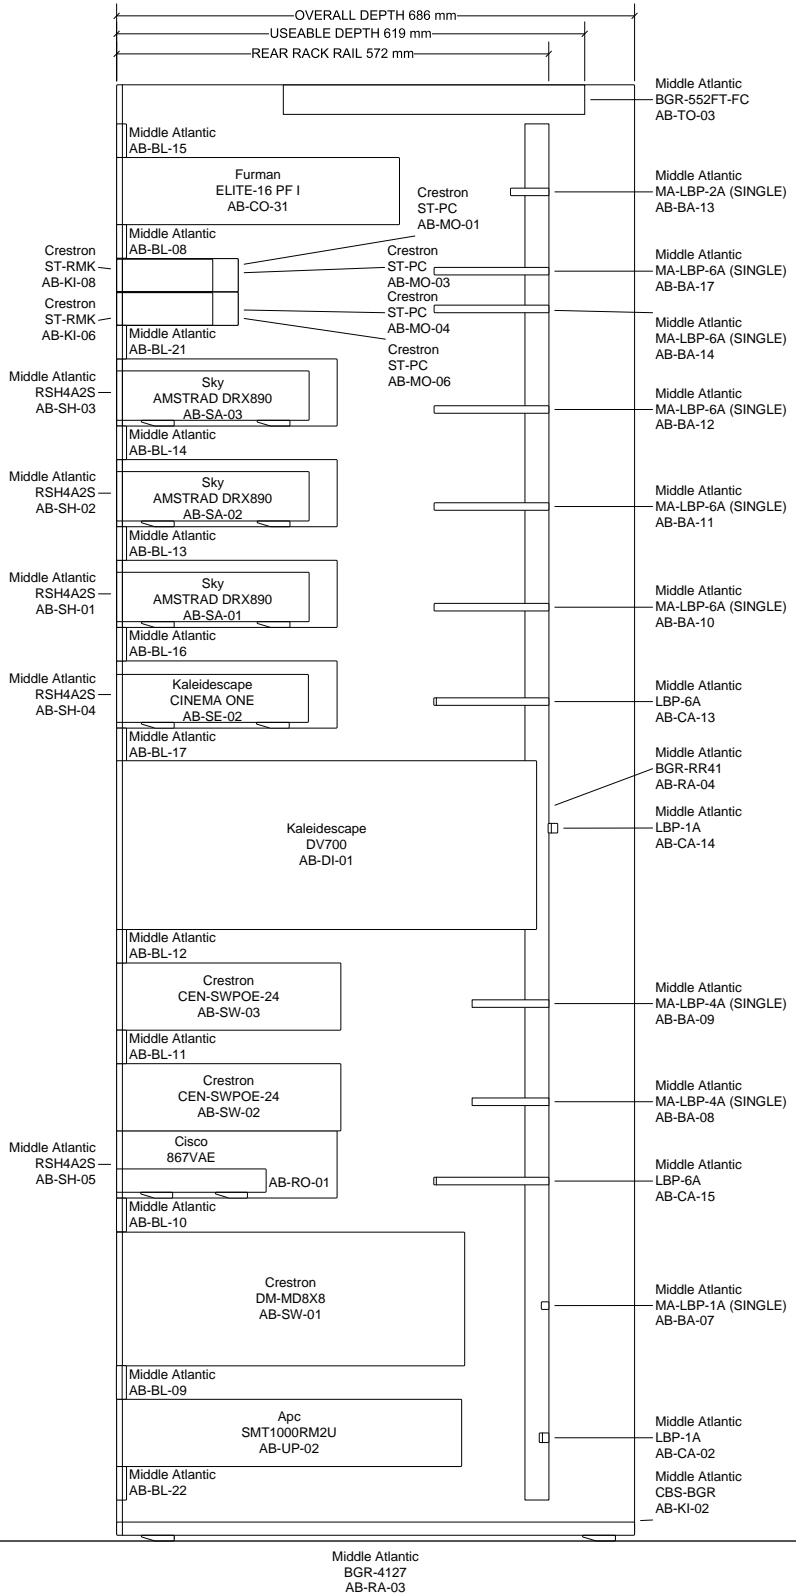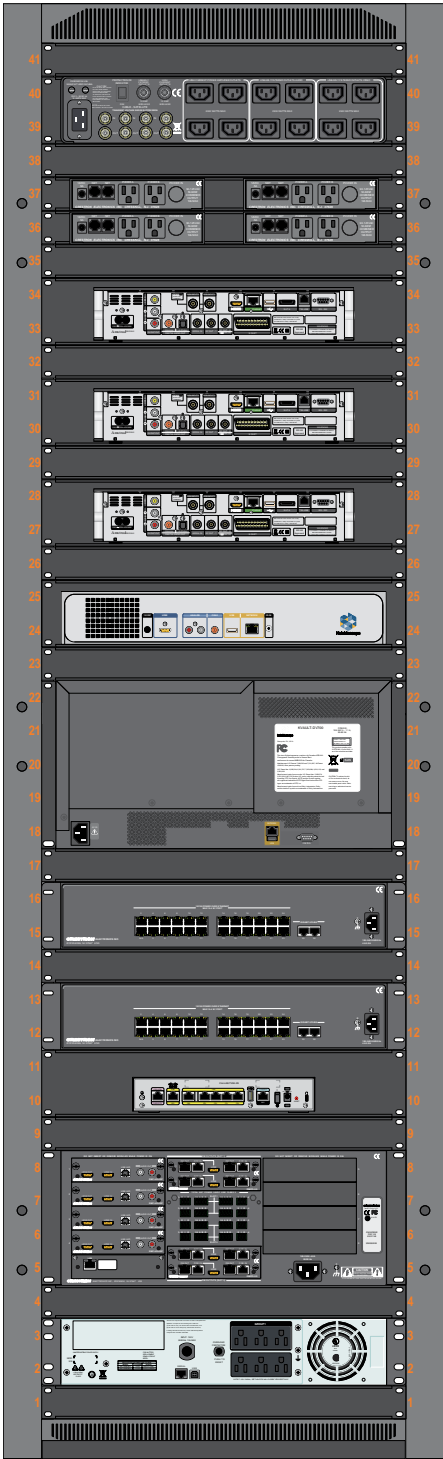

NOTES:

P0 Drawn KJ 05/10/16
REV: DESCRIPTION: BY: DATE:
STATUS: Preliminary - not for construction
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CEDIA MEMBER

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[your tagline]

INTEGRATOR:
[your brand]
100 Your Road,
Your Town., YT1 1YT.

CLIENT:

SITE:

TITLE:
Main Rack Right Build

SCALE: 1:5 @A1	DATE: 05/10/2016	DRAWN: KJ	CHECKED: KA
PROJECT NO: YB_02_C	DRAWING NO:	REVISION: P0	

KALEIDESCAPE	AB-SE-02	CINEMA ONE
	RCA - LRAUD - ZONE 2	
	RCA - LRAUD - ZONE 3	
IN	VLAN 2 IP: 10.196.65.72/255.255.255.0	OUT

A - GROUNDIAB - LOUNGE/DINER|HE-AV

AUTONOMIC CONTROL	AB-SE-01	MMS-5A
	RCA - AUD-LR - D-LR	
	RCA - AUD-LR - C-LR	
	RCA - AUD-LR - B-LR	
	RCA - AUD-LR - A-LR	
	RCA - D AUD - MAIN (DIG)	
IN	VLAN 2 IP: 10.196.65.101/255.255.255.0	OUT

A - GROUNDIAB - LOUNGE/DINER|HE-AV

CRESTRON	AB-SW-01	DM-MD8X8
IN	VLAN 1 IP: 10.196.64.31/255.255.255.0	OUT
CRESTRON	AB-CA-06	DMC-HD-DSP
	RCA - LRAUD - AUDIO LR	
	HDMI - DAV - HDMI	
IN		OUT
CRESTRON	AB-CA-05	DMC-HD-DSP
	RCA - LRAUD - AUDIO LR	
	HDMI - DAV - HDMI	
IN		OUT
CRESTRON	AB-CA-04	DMC-HD-DSP
	RCA - LRAUD - AUDIO LR	
	HDMI - DAV - HDMI	
IN		OUT
CRESTRON	AB-CA-03	DMC-HD-DSP
	RCA - LRAUD - AUDIO LR	
	HDMI - DAV - HDMI	
IN		OUT

A - GROUNDIAB - LOUNGE/DINER|HE-AV

CRESTRON	AB-SY-01	SWAMP-24X8
	L/R 1 - AUD - RCA	
	L/R 2 - AUD - RCA	
	L/R 3 - AUD - RCA	
	L/R 4 - AUD - RCA	
	L/R 5 - AUD - RCA	
	L/R 6 - AUD - RCA	
	L/R 7 - AUD - RCA	
	L/R 8 - AUD - RCA	
	L/R 9 - AUD - RCA	
	L/R 10 - AUD - RCA	
	TERM BLK - SPK - SPK L 1	
	TERM BLK - SPK - SPK R 1	
	TERM BLK - SPK - SPK L 2	
	TERM BLK - SPK - SPK R 2	
	TERM BLK - SPK - SPK L 3	
	TERM BLK - SPK - SPK R 3	
	TERM BLK - SPK - SPK L 4	
	TERM BLK - SPK - SPK R 4	
	TERM BLK - SPK - SPK L 5	
	TERM BLK - SPK - SPK R 5	
	TERM BLK - SPK - SPK L 6	
	TERM BLK - SPK - SPK R 6	
	TERM BLK - SPK - SPK L 7	
	TERM BLK - SPK - SPK R 7	
	TERM BLK - SPK - SPK L 8	
	TERM BLK - SPK - SPK R 8	
IN	VLAN 1 IP: 10.196.64.32/255.255.255.0	OUT

A - GROUNDIAB - LOUNGE/DINER|HE-AV

MARANTZ	AB-HQ-01	AV8802
	HDMI 1 - DAV - HDMI	
	HDMI 2 - DAV - HDMI	
	HDMI 3 - DAV - HDMI	
	HDMI 4 - DAV - HDMI	
	COAX 1 - DAUD - RCA	
	XLR - BAUD - FRONT L	
	XLR - BAUD - CENTER	
	XLR - BAUD - FRONT R	
	XLR - BAUD - SURR L	
	XLR - BAUD - BACK L	
	XLR - BAUD - SURR R	
	XLR - BAUD - BACK R	
	XLR - BAUD - H 1 L	
	XLR - BAUD - H 1 R	
	XLR - BAUD - H 2 L	
	XLR - BAUD - H 2 R	
	XLR - BAUD - SUB 1	
	XLR - BAUD - SUB 2	
IN	VLAN 1 IP: 10.196.64.33/255.255.255.0	OUT


A - GROUNDIAB - LOUNGE/DINER|HE-AV

CRESTRON	AB-AM-02	PROAMPI-7X250
	L - B AUD - XLR	
	R - B AUD - XLR	
	SL - B AUD - XLR	
	SR - B AUD - XLR	
	SBL - B AUD - XLR	
	SBR - B AUD - XLR	
IN	VLAN 1 IP: 10.196.64.41/255.255.255.0	OUT

A - GROUNDIAB - LOUNGE/DINER|HE-AV

CRESTRON	AB-AM-01	PROAMPI-7X250
	L - B AUD - XLR	
	R - B AUD - XLR	
	SL - B AUD - XLR	
	SR - B AUD - XLR	
	SBL - B AUD - XLR	
	SBR - B AUD - XLR	
IN	VLAN 1 IP: 10.196.64.23/255.255.255.0	OUT

A - GROUNDIAB - LOUNGE/DINER|HE-AV

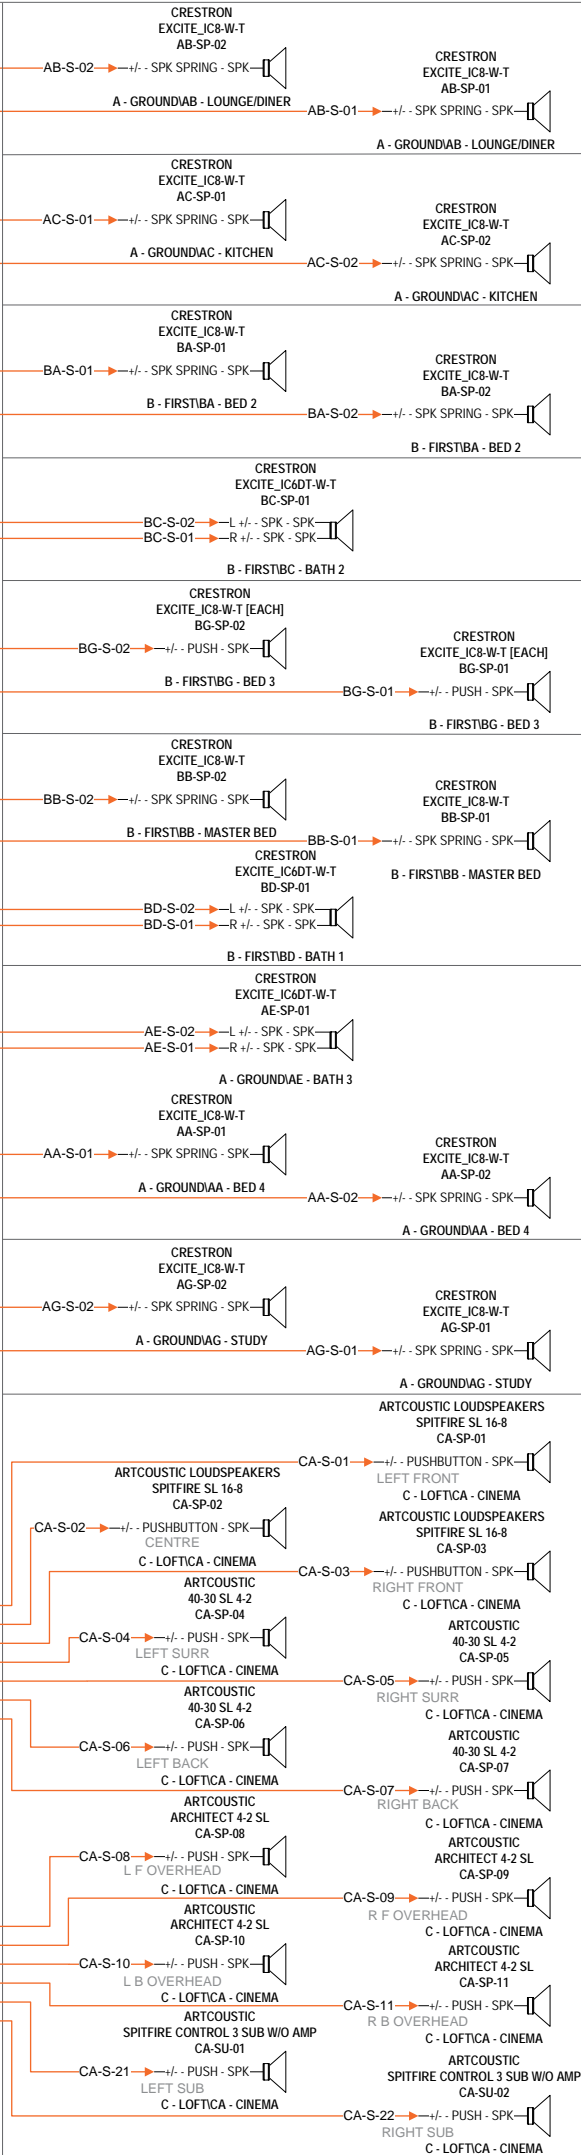

KALEIDESCAPE	AB-SE-02	CINEMA ONE
	HDMI - DAV - HDMI	
IN	VLAN 2 IP: 10.196.65.72/255.255.255.0	OUT

A - GROUNDIAB - LOUNGE/DINERIHE:AV

SKY	AB-SA-03	AMSTRAD DRX890
	HDMI - D-AV - HDMI	
IN	VLAN 2 IP: 10.196.65.53/255.255.255.0	OUT

A - GROUNDIAB - LOUNGE/DINERIHE:AV

SKY	AB-SA-02	AMSTRAD DRX890
	HDMI - D-AV - HDMI	
IN	VLAN 2 IP: 10.196.65.52/255.255.255.0	OUT

A - GROUNDIAB - LOUNGE/DINERIHE:AV

SKY	AB-SA-01	AMSTRAD DRX890
	HDMI - D-AV - HDMI	
IN	VLAN 2 IP: 10.196.65.51/255.255.255.0	OUT

A - GROUNDIAB - LOUNGE/DINERIHE:AV

CRESTRON	AB-SW-01	DM-MD8X8
IN	VLAN 1 IP: 10.196.64.31/255.255.255.0	OUT
CRESTRON	AB-CA-06	DMC-HD-DSP
IN		OUT
CRESTRON	AB-CA-05	DMC-HD-DSP
IN		OUT
CRESTRON	AB-CA-04	DMC-HD-DSP
IN		OUT
CRESTRON	AB-CA-03	DMC-HD-DSP
IN		OUT
CRESTRON	AB-CA-12	DMCO-55
IN		OUT
CRESTRON	AB-CA-11	DMCO-55
IN		OUT

A - GROUNDIAB - LOUNGE/DINERIHE:AV

CRESTRON	AB-SW-03	CEN-SWP0E-24
	RJ45 - DATA - 10/100 POE 8	
	RJ45 - DATA - 10/100 POE 7	
	RJ45 - DATA - 10/100 POE 6	
	RJ45 - DATA - 10/100 POE 5	
	RJ45 - DATA - 10/100 POE 4	
	RJ45 - DATA - 10/100 POE 3	
IN	VLAN 1 IP: 10.196.64.01/255.255.255.0	OUT

A - GROUNDIAB - LOUNGE/DINERIHE:AV

MARANTZ	AB-HO-01	AV8802
HDMI 1 - DAV - HDMI		HDMI - DVID - HDMI 1
HDMI 2 - DAV - HDMI		
HDMI 3 - DAV - HDMI		
HDMI 4 - DAV - HDMI		
IN	VLAN 1 IP: 10.196.64.33/255.255.255.0	OUT

A - GROUNDIAB - LOUNGE/DINERIHE:AV

CRESTRON	0-CON-086	HD-TX1-C
HDMI - D-AV - HDMI		RJ45 - AV - AV
IN		OUT

A - GROUNDIAB - LOUNGE/DINERIHE:AV

CRESTRON	CA-EX-01	HD-RX1-C
AV - AV - RJ45		HDMI - D-AV - HDMI
IN		OUT

C - LOFTICA - CINEMA

SONY	CA-PR-01	VPL-VW1000ES
HDMI 1 - D-AV - HDMI		
IN	VLAN 1 IP: 10.196.64.81/255.255.255.0	OUT

C - LOFTICA - CINEMA

CRESTRON	BB-CO-01	DM-RMC-100-C
DM IN - DM - RJ45		HDMI - D-AV - HDMI
		RJ45 - DATA - LAN
		TERM BLK - IR - IR - 1
IN	VLAN 1 IP: 10.196.64.132/255.255.255.0	OUT

B - FIRSTIBB - MASTER BED

SAMSUNG	BB-TV-01	UE55H6400AKXXU
HDMI 1 - DAV - HDMI		
ETHERNET - DATA - RJ45		
IN	VLAN 1 IP: 10.196.64.83/255.255.255.0	OUT

B - FIRSTIBB - MASTER BED

CRESTRON	AC-CO-01	DM-RMC-100-C
DM IN - DM - RJ45		HDMI - D-AV - HDMI
		RJ45 - DATA - LAN
		TERM BLK - IR - IR - 1
IN	VLAN 1 IP: 10.196.64.131/255.255.255.0	OUT

A - GROUNDIAC - KITCHEN

SAMSUNG	AC-TV-01	UE55H6400AKXXU
HDMI 1 - DAV - HDMI		
ETHERNET - DATA - RJ45		
IN	VLAN 1 IP: 10.196.64.84/255.255.255.0	OUT

A - GROUNDIAC - KITCHEN

CRESTRON	BG-CO-01	DM-RMC-100-C
DM IN - DM - RJ45		HDMI - D-AV - HDMI
		RJ45 - DATA - LAN
		TERM BLK - IR - IR - 1
IN	VLAN 1 IP: 10.196.64.134/255.255.255.0	OUT

B - FIRSTIBG - BED 3

SAMSUNG	BG-TV-01	UE55H6400AKXXU
HDMI 1 - DAV - HDMI		
ETHERNET - DATA - RJ45		
IN	VLAN 1 IP: 10.196.64.82/255.255.255.0	OUT

B - FIRSTIBG - BED 3

CRESTRON	AA-CO-01	DM-RMC-100-C
DM IN - DM - RJ45		HDMI - D-AV - HDMI
		RJ45 - DATA - LAN
		TERM BLK - IR - IR - 1
IN	VLAN 1 IP: 10.196.64.133/255.255.255.0	OUT

A - GROUNDIAA - BED 4

SAMSUNG	AA-TV-01	UE55H6400AKXXU
HDMI 1 - DAV - HDMI		
ETHERNET - DATA - RJ45		
IN	VLAN 1 IP: 10.196.64.85/255.255.255.0	OUT

A - GROUNDIAA - BED 4

CRESTRON	AB-CO-42	DM-RMC-100-C
DM IN - DM - RJ45		HDMI - D-AV - HDMI
		RJ45 - DATA - LAN
		TERM BLK - IR - IR - 1
		TERM BLK - RS-232 - COM
IN	VLAN 1 IP: 10.196.64.136/255.255.255.0	OUT

A - GROUNDIAB - LOUNGE/DINER

SAMSUNG	AB-TV-01	UE55H6400AKXXU
HDMI 1 - DAV - HDMI		
ETHERNET - DATA - RJ45		
IN	VLAN 1 IP: 10.196.64.86/255.255.255.0	OUT

A - GROUNDIAB - LOUNGE/DINER

FUTURE AUTOMATION	AB-PL-01	PLS
RS232 - CTRL - RJ25		
IN		OUT

A - GROUNDIAB - LOUNGE/DINER

CRESTRON	BA-CO-01	DM-RMC-100-C
DM IN - DM - RJ45		HDMI - D-AV - HDMI
		RJ45 - DATA - LAN
		TERM BLK - IR - IR - 1
IN	VLAN 1 IP: 10.196.64.135/255.255.255.0	OUT

B - FIRSTIBA - BED 2

SAMSUNG	BA-TV-01	UE55H6400AKXXU
HDMI 1 - DAV - HDMI		
ETHERNET - DATA - RJ45		
IN	VLAN 1 IP: 10.196.64.81/255.255.255.0	OUT

B - FIRSTIBA - BED 2

NOTES:

AUDIO/VIDEO



COMMUNICATIONS



SAFETY & SECURITY



ENVIRONMENTAL



CONTROL



ELECTRICAL



A0 Drawn KJ 05/10/16

REV: DESCRIPTION: BY: DATE:

STATUS: Preliminary - not for construction

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[your tagline]

INTEGRATOR:
[your brand]
100 Your Road,
Your Town., YT1 1YT.

CLIENT:

SITE:

TITLE: **Distributed Video/PoH/IR/RS232/LAN Schematic**

SCALE: NTS DATE: 05/10/2016 DRAWN: KJ CHECKED: KA

PROJECT NO: YB_02_C DRAWING NO: REVISION: A0

CRESTRON			AB-SW-03	CEN-SWPOE-24
			RJ45 - DATA - 10/100 POE 22	BB-C-01
			RJ45 - DATA - 10/100 POE 21	CA-C-01
			RJ45 - DATA - 10/100 POE 20	AB-C-01
			RJ45 - DATA - 10/100 POE 19	CA-D-01
			RJ45 - DATA - 10/100 POE 18	AB-C-21
			RJ45 - DATA - 10/100 POE 17	AB-C-20
			RJ45 - DATA - 10/100 POE 16	AB-C-35
			RJ45 - DATA - 10/100 POE 15	AB-C-34
			RJ45 - DATA - 10/100 POE 14	AB-C-33
			RJ45 - DATA - 10/100 POE 13	AB-C-23
			RJ45 - DATA - 10/100 POE 12	AB-C-22
			RJ45 - DATA - 10/100 POE 2	AB-C-36
			RJ45 - DATA - 10/100 POE 1	AB-C-32
IN			VLAN 1 IP: 10.196.64.01/255.255.255.0	OUT

A - GROUNDIAB - LOUNGE/DINER/H E-AV

CISCO			AB-RO-01	867VAE
			RJ45 - DATA - FE 1	
IN			VLAN 1 IP: 10.196.64.1/255.255.255.0	OUT

A - GROUNDIAB - LOUNGE/DINER/H E-AV

CRESTRON			AB-SW-02	CEN-SWPOE-24
			RJ45 - DATA - 10/100 POE 24	AB-C-36
			RJ45 - DATA - 10/100 POE 10	AB-C-11
			RJ45 - DATA - 10/100 POE 9	AB-C-12
			RJ45 - DATA - 10/100 POE 8	AB-C-13
			RJ45 - DATA - 10/100 POE 7	AB-C-10
			RJ45 - DATA - 10/100 POE 6	AB-C-08
			RJ45 - DATA - 10/100 POE 5	AB-C-09
			RJ45 - DATA - 10/100 POE 3	CA-D-03
			RJ45 - DATA - 10/100 POE 2	BE-C-01
			RJ45 - DATA - 10/100 POE 1	AC-D-02
IN			VLAN 2 IP: 10.196.65.01/255.255.255.0	OUT

A - GROUNDIAB - LOUNGE/DINER/H E-AV

CRESTRON			AB-SY-01	SWAMP-24X8
LAN - DATA - RJ45				
IN			VLAN 1 IP: 10.196.64.32/255.255.255.0	OUT

A - GROUNDIAB - LOUNGE/DINER/H E-AV

CRESTRON			AB-SW-01	DM-MD8X8
LAN - DATA - RJ45				
IN			VLAN 1 IP: 10.196.64.31/255.255.255.0	OUT

A - GROUNDIAB - LOUNGE/DINER/H E-AV

CRESTRON			AB-AM-01	PROAMPL-7X250
LAN - DATA - RJ45				
IN			VLAN 1 IP: 10.196.64.23/255.255.255.0	OUT

A - GROUNDIAB - LOUNGE/DINER/H E-AV

MARANTZ			AB-HQ-01	AV8802
NET - DATA - RJ45				
IN			VLAN 1 IP: 10.196.64.33/255.255.255.0	OUT

A - GROUNDIAB - LOUNGE/DINER/H E-AV

CRESTRON			AB-AM-02	PROAMPL-7X250
LAN - DATA - RJ45				
IN			VLAN 1 IP: 10.196.64.41/255.255.255.0	OUT

A - GROUNDIAB - LOUNGE/DINER/H E-AV

CRESTRON			AB-PR-02	CP3
			TERMBLK - CRESNET - NET	AB-C-07
			TERM BLK - CTRL - COM-COM C	AB-D-04
			TERM BLK - CTRL - COM-COM B	AB-D-02
			TERM BLK - CTRL - COM-COM A	AB-D-03
			TERMBLK - IR - IR OUT-IR C	AB-I-04
			TERMBLK - IR - IR OUT-IR B	AB-I-03
			TERMBLK - IR - IR OUT-IR A	AB-I-02
ETHERNET - DATA - RJ45				
IN			VLAN 1 IP: 10.196.64.22/255.255.255.0 - CRESNET ID: 02	OUT

A - GROUNDIAB - LOUNGE/DINER/H E-AV

CRESTRON			AB-PR-01	CP3
ETHERNET - DATA - RJ45				
IN			VLAN 1 IP: 10.196.64.21/255.255.255.0 - CRESNET ID: 01	OUT

A - GROUNDIAB - LOUNGE/DINER/H E-AV

KALEIDESCAPE			AB-SE-02	CINEMA ONE
NETWORK - DATA - RJ45				
IN			VLAN 2 IP: 10.196.65.72/255.255.255.0	OUT

A - GROUNDIAB - LOUNGE/DINER/H E-AV

KALEIDESCAPE			AB-DI-01	DV700
NETWORK - DATA - RJ45				
IN			VLAN 2 IP: 10.196.65.73/255.255.255.0	OUT

A - GROUNDIAB - LOUNGE/DINER/H E-AV

AUTONOMIC CONTROLS			AB-SE-01	MMS-5A
ETHERNET - DATA - RJ45				
IN			VLAN 2 IP: 10.196.65.101/255.255.255.0	OUT

A - GROUNDIAB - LOUNGE/DINER/H E-AV

CRESTRON			AB-MO-06	ST-PC
NET-NET 2 - CRESNET - RJ11				
IN			CRESNET ID: 16	OUT

A - GROUNDIAB - LOUNGE/DINER/H E-AV

CRESTRON			AB-MO-05	ST-PC
NET-NET 2 - CRESNET - RJ11				
IN			CRESNET ID: 15	OUT

A - GROUNDIAB - LOUNGE/DINER/H E-AV

CRESTRON			AB-MO-02	ST-PC
NET-NET 2 - CRESNET - RJ11				
IN			CRESNET ID: 14	OUT

A - GROUNDIAB - LOUNGE/DINER/H E-AV

CRESTRON			AB-MO-03	ST-PC
NET-NET 2 - CRESNET - RJ11				
IN			CRESNET ID: 13	OUT

A - GROUNDIAB - LOUNGE/DINER/H E-AV

CRESTRON			AB-MO-01	ST-PC
NET-NET 2 - CRESNET - RJ11				
IN			CRESNET ID: 12	OUT

A - GROUNDIAB - LOUNGE/DINER/H E-AV

CRESTRON			AB-MO-04	ST-PC
NET-NET 2 - CRESNET - RJ11				
IN			CRESNET ID: 11	OUT

A - GROUNDIAB - LOUNGE/DINER/H E-AV

APC			AB-UP-01	SMT1000RM2U
SERIAL - DATA - RJ45				
IN				OUT

A - GROUNDIAB - LOUNGE/DINER/H E-AV

CRESTRON			0-CON-086	HD-TX1-C
COM - CTRL - TERM				
IN			RJ45 - AV - AV	OUT

A - GROUNDIAB - LOUNGE/DINER/H E-AV

SCREEN EXCELLENCE			CA-IN-13	ROBRIDGE
RS232 - Control - RJ11				
IN			RJ14 - Control - RO BUS 2	OUT

C - LOFTICA - CINEMA

SKY			AB-SA-03	AMSTRAD DRX890
RFout 2 - RF - COAX				
IN			ETHERNET - DATA - RJ45	OUT

A - GROUNDIAB - LOUNGE/DINER/H E-AV

SKY			AB-SA-02	AMSTRAD DRX890
RFout 2 - RF - COAX				
IN			ETHERNET - DATA - RJ45	OUT

A - GROUNDIAB - LOUNGE/DINER/H E-AV

SKY			AB-SA-01	AMSTRAD DRX890
RFout 2 - RF - COAX				
IN			ETHERNET - DATA - RJ45	OUT

A - GROUNDIAB - LOUNGE/DINER/H E-AV

CRESTRON			CA-EX-01	HD-RX1-C
AV - AV - RJ45				
IN			TERM - CTRL - COM	OUT

C - LOFTICA - CINEMA

SCREEN EXCELLENCE			CA-IN-12	CB2/10
RS-CTRL - RJ14				
IN			TERMBLK - 230VAC - SCN	OUT

C - LOFTICA - CINEMA

CRESTRON			BB-TP-01	TSW-750
LAN POE - DATA&POE - RJ45				
IN			VLAN 1 IP: 10.196.64.162/255.255.255.0	OUT

B - FIRSTBB - MASTER BED

CRESTRON			CA-TP-01	TSW-750
LAN POE - DATA&POE - RJ45				
IN			VLAN 1 IP: 10.196.64.155/255.255.255.0	OUT

C - LOFTICA - CINEMA

CRESTRON			AB-TP-01	TSW-750
LAN POE - DATA&POE - RJ45				
IN			VLAN 1 IP: 10.196.64.154/255.255.255.0	OUT

A - GROUNDIAB - LOUNGE/DINER

SONY			CA-PR-01	VPL-VW1000ES
LAN - DATA - RJ45				
IN			RS-232 - CTRL - DB9F	OUT

C - LOFTICA - CINEMA

SCREEN EXCELLENCE			CA-FI-01	TAM2-130
AC - POWER - AC				
IN				OUT

C - LOFTICA - CINEMA

CISCO MERAKI			CA-AP-01	MR18-HW
10/100/1000 - DATA POE - RJ45				
IN			VLAN 2 IP: 10.196.65.203/255.255.255.0	OUT

C - LOFTICA - CINEMA

CISCO MERAKI			BE-AP-01	MR18-HW
10/100/1000 - DATA POE - RJ45				
IN			VLAN 2 IP: 10.196.65.202/255.255.255.0	OUT

B - FIRSTBE - CUPBOARD

CISCO MERAKI			AC-AP-01	MR18-HW
10/100/1000 - DATA POE - RJ45				
IN			VLAN 2 IP: 10.196.65.201/255.255.255.0	OUT

A - GROUNDIAC - KITCHEN

NOTES:

AUDIO/VIDEO

COMMUNICATIONS

SAFETY & SECURITY

ENVIRONMENTAL

CONTROL

ELECTRICAL

A0 Drawn KJ 05/10/16

REV: DESCRIPTION: BY: DATE:

STATUS: Preliminary - not for construction

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CLIENT:

SITE:

TITLE: Control/Network/PoE Schematic

SCALE: NTS DATE: 05/10/2016 DRAWN: KJ CHECKED: KA

PROJECT NO: YB_02_C DRAWING NO: REVISION: A0

APC	AB-UP-01	SMT1000RM2U
13 AMP - POWER - IEC		IE/(AB-M-01)-4
IN		OUT

A - GROUND/AB - LOUNGE/DINER/H&E:AV

FURMAN	AB-CO-41	ELITE-16 PF I
	IEC - POWER - FILTERED VIDEO	
	IEC - POWER - FILTERED VIDEO	
	IEC - POWER - FILTERED AUDIO	
16 AMP - POWER - 16 AMP		IEC - POWER - HC POWER AMPS
IN		OUT

A - GROUND/AB - LOUNGE/DINER/H&E:AV

TDI	AB-PO-03	CM-0110
13 AMP - POWER - CAPTIVE		3 PIN - POWER - 1
		3 PIN - POWER - 2
IN		OUT

A - GROUND/AB - LOUNGE/DINER/H&E:AV

CRESTRON	AB-MO-02	ST-PC
POWER IN-AC - AC - ACPLUG		ACPLUG - AC - POWER OUT-A
		ACPLUG - AC - POWER OUT-B
IN	CRESNET ID: 14	OUT

A - GROUND/AB - LOUNGE/DINER/H&E:AV

CRESTRON	0-POW-008	PW-2407WU
- - POWER - 3 PIN AC PLUG		DC - POWER - CAPTIVE
IN		OUT

A - GROUND/AB - LOUNGE/DINER/H&E:AV

MIDDLE ATLANTIC	AB-TO-03	BGR-552FT-FC
AC - POWER - IEC		
IN		OUT

A - GROUND/AB - LOUNGE/DINER/H&E:AV

CRESTRON	AB-MO-05	ST-PC
POWER IN-AC - AC - ACPLUG		ACPLUG - AC - POWER OUT-A
		ACPLUG - AC - POWER OUT-B
IN	CRESNET ID: 15	OUT

A - GROUND/AB - LOUNGE/DINER/H&E:AV

CRESTRON	AB-SY-01	SWAMP-24X8
230 VAC - POWER - IEC		
IN	VLAN 1 IP: 10.196.64.32/255.255.255.0	OUT

A - GROUND/AB - LOUNGE/DINER/H&E:AV

CRESTRON	AB-AM-02	PROAMPI-7X250
AC - POWER - IEC		
IN	VLAN 1 IP: 10.196.64.41/255.255.255.0	OUT

A - GROUND/AB - LOUNGE/DINER/H&E:AV

CRESTRON	AB-AM-01	PROAMPI-7X250
AC - POWER - IEC		
IN	VLAN 1 IP: 10.196.64.23/255.255.255.0	OUT

A - GROUND/AB - LOUNGE/DINER/H&E:AV

CRESTRON	AB-PO-02	PW-2420RU
- - POWER - IEC		DC - POWER - CAPTIVE
IN		OUT

A - GROUND/AB - LOUNGE/DINER/H&E:AV

CRESTRON	AB-PR-02	CP3
POWER - POWER - 3.5MM		
IN	VLAN 1 IP: 10.196.64.22/255.255.255.0 - CRESNET ID: 02	OUT

A - GROUND/AB - LOUNGE/DINER/H&E:AV

CRESTRON	AB-PO-01	PW-2420RU
- - POWER - IEC		DC - POWER - CAPTIVE
IN		OUT

A - GROUND/AB - LOUNGE/DINER/H&E:AV

CRESTRON	AB-PR-01	CP3
POWER - POWER - 3.5MM		
IN	VLAN 1 IP: 10.196.64.21/255.255.255.0 - CRESNET ID: 01	OUT

A - GROUND/AB - LOUNGE/DINER/H&E:AV

CRESTRON	0-CON-086	HD-TX1-C
24VDC - POWER - DC 24V		
IN		OUT

A - GROUND/AB - LOUNGE/DINER/H&E:AV

MARANTZ	AB-HO-01	AV8802
AC - POWER - C18		
IN	VLAN 1 IP: 10.196.64.33/255.255.255.0	OUT

A - GROUND/AB - LOUNGE/DINER/H&E:AV

AUTONOMIC CONTROLS	AB-SE-01	MMS-5A
DC IN - POWER - DC		
IN	VLAN 2 IP: 10.196.65.101/255.255.255.0	OUT

A - GROUND/AB - LOUNGE/DINER/H&E:AV

KALEIDESCAPE	AB-SE-02	CINEMA ONE
AC - POWER - C14		
IN	VLAN 2 IP: 10.196.65.72/255.255.255.0	OUT

A - GROUND/AB - LOUNGE/DINER/H&E:AV

CRESTRON	AB-MO-03	ST-PC
POWER IN-AC - AC - ACPLUG		ACPLUG - AC - POWER OUT-A
		ACPLUG - AC - POWER OUT-B
IN	CRESNET ID: 13	OUT

A - GROUND/AB - LOUNGE/DINER/H&E:AV

KALEIDESCAPE	AB-DI-01	DV700
AC - POWER - C14		
IN	VLAN 2 IP: 10.196.65.73/255.255.255.0	OUT

A - GROUND/AB - LOUNGE/DINER/H&E:AV

CRESTRON	AB-MO-01	ST-PC
POWER IN-AC - AC - ACPLUG		ACPLUG - AC - POWER OUT-A
		ACPLUG - AC - POWER OUT-B
IN	CRESNET ID: 12	OUT

A - GROUND/AB - LOUNGE/DINER/H&E:AV

SKY	AB-SA-03	AMSTRAD DRX890
AC - AC - FIGURE 8		
IN	VLAN 2 IP: 10.196.65.53/255.255.255.0	OUT

A - GROUND/AB - LOUNGE/DINER/H&E:AV

CRESTRON	AB-MO-04	ST-PC
POWER IN-AC - AC - ACPLUG		ACPLUG - AC - POWER OUT-A
		ACPLUG - AC - POWER OUT-B
IN	CRESNET ID: 11	OUT

A - GROUND/AB - LOUNGE/DINER/H&E:AV

SKY	AB-SA-02	AMSTRAD DRX890
AC - AC - FIGURE 8		
IN	VLAN 2 IP: 10.196.65.52/255.255.255.0	OUT

A - GROUND/AB - LOUNGE/DINER/H&E:AV

CRESTRON	AB-MO-04	ST-PC
POWER IN-AC - AC - ACPLUG		ACPLUG - AC - POWER OUT-A
		ACPLUG - AC - POWER OUT-B
IN	CRESNET ID: 11	OUT

A - GROUND/AB - LOUNGE/DINER/H&E:AV

SKY	AB-SA-02	AMSTRAD DRX890
AC - AC - FIGURE 8		
IN	VLAN 2 IP: 10.196.65.52/255.255.255.0	OUT

A - GROUND/AB - LOUNGE/DINER/H&E:AV

CRESTRON	AB-SW-01	DM-MD8X8
AC - POWER - IEC		
IN	VLAN 1 IP: 10.196.64.31/255.255.255.0	OUT

A - GROUND/AB - LOUNGE/DINER/H&E:AV

SKY	AB-SA-01	AMSTRAD DRX890
AC - AC - FIGURE 8		
IN	VLAN 2 IP: 10.196.65.51/255.255.255.0	OUT

A - GROUND/AB - LOUNGE/DINER/H&E:AV

CRESTRON	AB-SW-01	DM-MD8X8
AC - POWER - IEC		
IN	VLAN 1 IP: 10.196.64.31/255.255.255.0	OUT

A - GROUND/AB - LOUNGE/DINER/H&E:AV

SKY	AB-SA-01	AMSTRAD DRX890
AC - AC - FIGURE 8		
IN	VLAN 2 IP: 10.196.65.51/255.255.255.0	OUT

A - GROUND/AB - LOUNGE/DINER/H&E:AV

MIDDLE ATLANTIC	AB-TO-01	BGR-552FT-FC
AC - POWER - IEC		
IN		OUT

A - GROUND/AB - LOUNGE/DINER/H&E:AV

CRESTRON	AB-SW-03	CEN-SWPOE-24
AC - POWER - IEC		
IN	VLAN 1 IP: 10.196.64.01/255.255.255.0	OUT

A - GROUND/AB - LOUNGE/DINER/H&E:AV

CRESTRON	AB-MO-06	ST-PC
POWER IN-AC - AC - ACPLUG		ACPLUG - AC - POWER OUT-A
		ACPLUG - AC - POWER OUT-B
IN	CRESNET ID: 16	OUT

A - GROUND/AB - LOUNGE/DINER/H&E:AV

CRESTRON	AB-SW-02	CEN-SWPOE-24
AC - POWER - IEC		
IN	VLAN 2 IP: 10.196.65.01/255.255.255.0	OUT

A - GROUND/AB - LOUNGE/DINER/H&E:AV

APC	AB-UP-02	SMT1000RM2U
13 AMP - POWER - IEC		IEC - POWER - 1
		IEC - POWER - 2
IN		OUT

A - GROUND/AB - LOUNGE/DINER/H&E:AV

CISCO	AB-RO-01	867VAE
12VDC - POWER - DCPLUG		
IN	VLAN 1 IP: 10.196.64.1/255.255.255.0	OUT

A - GROUND/AB - LOUNGE/DINER/H&E:AV



SAMSUNG	AB-TV-01	UE55H6400AKXXU
POWER - POWER - ACPLUG		
IN	VLAN 1 IP: 10.196.64.86/255.255.255.0	OUT

A - GROUND/AB - LOUNGE/DINER



FUTURE AUTOMATION	AB-PL-01	PLS
MAINS - POWER - C14		
IN		OUT

A - GROUND/AB - LOUNGE/DINER



SAMSUNG	AC-TV-01	UE55H6400AKXXU
POWER - POWER - ACPLUG		
IN	VLAN 1 IP: 10.196.64.84/255.255.255.0	OUT

A - GROUND/AC - KITCHEN



SAMSUNG	BA-TV-01	UE55H6400AKXXU
POWER - POWER - ACPLUG		
IN	VLAN 1 IP: 10.196.64.81/255.255.255.0	OUT

B - FIRST/BA - BED 2



SAMSUNG	BG-TV-01	UE55H6400AKXXU
POWER - POWER - ACPLUG		
IN	VLAN 1 IP: 10.196.64.82/255.255.255.0	OUT

B - FIRST/BG - BED 3



SAMSUNG	BB-TV-01	UE55H6400AKXXU
POWER - POWER - ACPLUG		
IN	VLAN 1 IP: 10.196.64.83/255.255.255.0	OUT

B - FIRST/BB - MASTER BED



SAMSUNG	AA-TV-01	UE55H6400AKXXU
POWER - POWER - ACPLUG		
IN	VLAN 1 IP: 10.196.64.85/255.255.255.0	OUT

A - GROUND/AA - BED 4



SCREEN EXCELLENCE	CA-FI-01	TAM2-130
AC - POWER - AC		
IN		OUT

C - LOFT/CA - CINEMA



SONY	CA-PR-01	VPL-VW1000ES
230 V - POWER - IEC		
IN	VLAN 1 IP: 10.196.64.81/255.255.255.0	OUT

C - LOFT/CA - CINEMA

NOTES:

AUDIO/VIDEO



COMMUNICATIONS



SAFETY & SECURITY



ENVIRONMENTAL



CONTROL



ELECTRICAL



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